GREENPORT, NY

SCHEMATIC DESIGN

THE TURETT COLLABORATIVE 277 BROADWAY, SUITE 1300 NEW YORK, NY, 10007 212.965.1244

SHEET LIST

COVER SHEET T-000 Z-001 **EXISTING SURVEY** Z-002 NEW PROPOSED SITE PLAN G-001 **GENERAL NOTES** SYMBOLS AND ABBREVIATIONS **CONSTRUCTION PLAN - LEVEL 1** CONSTRUCTION PLAN - LEVEL 2 CONSTRUCTION PLAN - ROOF BUILDING ELEVATIONS - NORTH & SOUTH **BUILDING ELEVATIONS - EAST & WEST BUILDING SECTION BUILDING SECTION B** PARTITION TYPES PARTITION TYPES CONT. DOOR AND WINDOW SCHEDULE

225 MONSELL PLACE

ISSUE/REVISION

1 Revision 1

2 Rev 2

08/04/2021 04/06/22

DATE

CONSULTANTS

ARCHITECT THE TURETT 277 BROADWAY, SUITE 1300 NEW YORK, NY, 10007 212.965.1244

STRUCTURAL ENGINEER

XXXX XXXX XXXX

MECHANICAL ENGINEER

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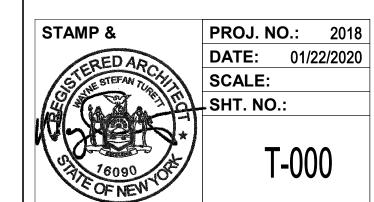
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DRAWING TITLE

COVER SHEET



GENERAL NOTES

- THE CONSTRUCTION MANAGER/GENERAL CONTRACTOR SHALL VERIFY ALL EXISTING CONDITIONS IN THE FIELD PRIOR TO COMMENCING WORK, AND SHALL REPORT ANY DISCREPANCIES BETWEEN DRAWINGS AND FIELD CONDITIONS TO
- MINOR DETAILS NOT USUALLY SHOWN OR SPECIFIED, BUT NECESSARY FOR PROPER CONSTRUCTION OF ANY PART OF THE WORK SHALL BE INCLUDED AS IF THEY WERE INDICATED IN THE DRAWINGS.
- THE GENERAL CONTRACTOR SHALL COORDINATE ALL WORK PROCEDURES WITH REQUIREMENTS OF LOCAL AUTHORITIES.
- ALL DIMENSIONS ARE FROM FINISHED WALLS AND PARTITIONS UNLESS OTHERWISE INDICATED. WRITTEN DIMENSIONS TAKE PRECEDENCE OVER SCALED DIMENSIONS. WALLS SHOWN TO 'ALIGN' SHALL BE FINISHED FLUSH AND SMOOTH WITH EXISTING WORK. AFTER THE PARTITION WALLS HAVE BEEN LAID OUT THE ARCHITECT IS TO BE NOTIFIED SO THAT WORK MAY BE INSPECTED AND APPROVED FOR CONFORMANCE WITH DESIGN BEFORE PROCEEDING WITH ADDITIONAL CONSTRUCTION.
- ALL WORK TO BE COORDINATED BY GENERAL CONTRACTOR UNLESS OTHERWISE NOTED. ANY SUBSTITUTE IN SPECIFICATIONS MUST BE SUBMITTED TO THE ARCHITECT FOR APPROVAL. SHOULD THE CONTRACTOR FIND ANY DISCREPANCIES, OMISSIONS, AMBIGUITIES, OR CONFLICTS IN ANY OF THE CONSTRUCTION DRAWINGS, OR BE IN DOUBT AS TO THEIR MEANING, THEY MUST BRING THE QUESTION TO THE ATTENTION OF THE ARCHITECT PRIOR TO START OF CONSTRUCTION. THE ARCHITECT SHALL REVIEW THE QUESTION AND WHERE INFORMATION SOUGHT IS NOT CLEARLY INDICATED OR SPECIFIED, WILL ISSUE A CLARIFYING ADDENDUM. NEITHER THE OWNER NOR THE ARCHITECT WILL BE RESPONSIBLE FOR VERBAL INSTRUCTIONS.
- WRITTEN REQUEST MUST SUBMITTED FOR ANY PROPOSED CHANGES IN SCOPE OF THE WORK BY THE GENERAL CONTRACTOR TO THE CLIENT AND ARCHITECT BEFORE ANY WORK IS STARTED, SUCH REQUESTS SHALL INDICATE SCOPE OF WORK, COST, AND POSSIBLE DELAYS TO THE PROJECT.
- THE GENERAL CONTRACTOR SHALL BE RESPONSIBLE FOR PROTECTION OF ALL CONDITIONS AND MATERIALS WITHIN THE PROPOSED CONSTRUCTION AREA AND ALL COMMON SPACES LEADING TO AND FROM THE CONSTRUCTION AREA. GENERAL CONTRACTOR SHALL HAVE SOLE RESPONSIBILITY FOR ANY DAMAGE OR INJURIES CAUSED BY OR DURING
- THE DRAWINGS MAY NOT SHOW ALL ITEMS OR OBJECTS EXISTING AT THE SITE. THE CONTRACTOR MUST VERIFY AT THE SITE ALL OBJECTS TO BE PRESERVED AND REPORT TO THE ARCHITECT ANY DISCREPANCIES OR QUESTIONABLE
- USE ALL MEANS NECESSARY TO PROTECT EXISTING OBJECTS DESIGNED TO REMAIN AND IN THE EVENT OF DAMAGE, IMMEDIATELY MAKE ALL REPAIRS AND REPLACEMENT NECESSARY TO THE APPROVAL OF THE ARCHITECT AT NO ADDITIONAL EXPENSE TO THE OWNER.
- PRIOR TO COMMENCEMENT, CAREFULLY INSPECT THE ENTIRE SITE AND ALL OBJECTS DESIGNATED TO BE REMOVED AND TO BE PRESERVED, AS WELL AS ALL EXISTING UTILITIES. THE GENERAL CONTRACTOR SHALL REMOVE, REROUTE/OR CAP OFF ALL UNUSED UTILITIES AFTER CHECKING WITH THE ARCHITECT. THESE ITEMS SHALL BE CAPPED OFF WITHIN EXISTING WALLS OR FLOORS.
- PARTITIONS: A.ALL OUTSIDE CORNERS AT MASONRY AND DRYWALL PARTITIONS SHALL HAVE METAL CORNER BEADS. TAPE AND SPACKLE SMOOTH WHERE REQUIRED. THREE COAT SPACKLE FINISH MIN. B. ALL DEFECTIVE PLASTER AND/OR DRYWALL ON ADJACENT EXISTING WALLS SHALL BE CHOPPED OUT AND/OR PATCHED FREE OF IRREGULARITIES AND SHALL MATCH ADJACENT WALLS IN FINISH AND THICKNESS. C. ALIGNMENT OF NEW WALL CONSTRUCTION TO EXISTING WALLS AND COLUMNS SHALL BE DONE IN A MANNER AS TO VISIBLY ELIMINATE THE POINT OF CONTACT OR JOINT OF NEW AND EXISTING MATERIALS. D.WHERE DEMOLITION HAS OCCURRED, CONTRACTOR SHALL FILL ALL HOLES, PATCH SMOOTH AND LEVEL ALL
- ALL SURFACES TO RECEIVE FINISHES. CLEAN UP: THE GENERAL CONTRACTOR SHALL KEEP THE SITE FREE FROM ACCUMULATION OF MATERIAL AND DEBRIS. PREMISES SHALL BE LEFT BROOM CLEAN AT THE CLOSE OF EVERY WORK DAY. CONTRACTORS MUST PROVIDE THEIR OWN DUMPSTERS. ALL PAINT BRUSHES, ETC. MUST BE CLEANED IN SLOP SINKS LOCATED EITHER IN THE BACK HALLWAYS OR IN THE BASEMENT. CONTRACTOR SHALL BE RESPONSIBLE FOR THE REMOVAL OF ALL UNWANTED EQUIPMENT AND DEBRIS AT THE COMPLETION OF CONSTRUCTION. AT THE COMPLETION OF THE WORK, THE GENERAL

REMAINING SURFACES, INCLUDING WALLS, FLOORS, AND CEILINGS, SQUARE ALL CORNERS AND PROPERLY PREPARE

- A.CLEAN FIXTURES, EQUIPMENT, FINISH HARDWARE, PAINTED AND DECORATED SURFACES, AND REMOVE MARKS. STAINS, PAINT, DIRT, AND OTHER SOILING RESULTING FROM THE WORK OF THIS CONTRACT.
- ALL BUILDING MATERIALS STORED AT CONSTRUCTION AREA ARE TO BE SECURED IN A LOCKED AREA WITH ACCESS
- CONTROLLED BY THE OWNER AND/OR GENERAL CONTRACTOR. ALL MATERIAL RO BE STORED IN AN ORDERLY FASHION.
- ALL FLAMMABLE MATERIALS ARE TO BE KEPT TIGHTLY SEALED IN THEIR ORIGINAL CONTAINERS. SUCH MATERIALS
- SHALL BE KEPT AWAY FROM HEAT OR OPEN FLAMES. ALL FLAMMABLE MATERIALS TO BE USED AND STORED IN AN ADEQUATELY VENTILATED SPACE.

CONTRACTOR SHALL PERFORM THE FOLLOWING CLEANING:

- ALL ELECTRICAL POWER IS TO BE SHUT OFF WHERE THERE IS AN EXPOSED CONDUIT.
- ALL ELECTRICAL POWER IN THE CONSTRUCTION AREA IS TO BE SHUT OFF AFTER WORKING HOURS. GENERAL CONTRACTOR AT ALL TIMES SHALL MAKE SURE THERE IS NO LEAKAGE OF NATURAL GAS IN BUILDING, OR ANY OTHER FLAMMABLE GAS USED IN CONSTRUCTION.
- GENERAL CONTRACTOR SHALL NOT BURN ANY DEBRIS OR MAINTAIN ANY OPEN FLAMES ON THE SITE.

PLUMBING NOTES

- 1 ALL PLUMBING WORK SHALL BE PERFORMED BY A LICENSED PLUMBER.
- 2 PLUMBER MUST CHECK EXISTING WASTE AND VENT LINES TO BE FREE OF OBSTRUCTION.
- 3 PROVIDE NEW ISOLATION VALVES AND BRANCH LINES FOR HOT AND COLD WATER SUPPLY FOR RENOVATED BATHROOMS AND KITCHEN. ALL NEW COPPER PIPING SHALL BE PROVIDED FROM THE ISOLATION VALVE TO EACH FIXTURE. ALL NEW SHUTOFF VALVES TO BE PROVIDED AT EACH FIXTURE.

ELECTRICAL NOTES

1 ALL ELECTRICAL WORK SHALL BE PERFORMED BY A NY STATE LICENSED ELECTRICIAN AND ALL WORK SHALL BE IN ACCORDANCE WITH LOCAL JURISDICTION.

CARBON MONOXIDE ALARM NOTES

1 CARBON MONOXIDE ALARMS SHALL BE INSTALLED AS REQUIRED BY R315-CARBON MONOXIDE ALARMS

SMOKE DETECTOR NOTES (DWELLING UNITS)

- SMOKE DETECTORS SHALL BE INSTALLED AS REQUIRED BY R314 SMOKE ALARMS AND HEAT DETECTION.
- 2 DETECTORS SHALL BE EITHER IONIZATION CHAMBERS OR PHOTOELECTRIC TYPES.
- 3 UNITS TO BE APPROVED BY BOARD OF STANDARDS AND APPEALS ACCEPTED PURSUANT TO RULES AND REGULATIONS PROMULGATED BY THE COMMISSIONER OR LISTED BY AN ACCEPTABLE TESTING LABORATORY, SUCH
- UNDERWRITER'S LABORATORY, NORTHBROOK, ILLINOIS, MEA LAB.; CANADIAN STANDARD ASSOCIATION, ONTARIO, CANADA, UNDERWRITER'S LAB. OF CANADA, ONTARIO, CANADA, MEA. LAB.
- UNITS SHALL BE INSTALLED IN AREAS DESIGNATED ON PLANS; THEY SHALL BE LOCATED ON OR NEAR THE CEILINGS AND WITHIN 15'-0" OF ANY ROOMS USED FOR SLEEPING PURPOSES; FOR DWELLING UNITS WITH MULTIPLE LEVELS, WHEN ANY LEVEL HAS ONLY ONE MEANS OF EGRESS, UNITS SHALL BE PROVIDED AT ALL LEVELS.
- UNITS SHALL BE INSTALLED IN AREAS DESIGNATED ON PLANS; THEY SHALL BE LOCATED ON OR NEAR THE CEILINGS AND WITHIN 15'-0" OF ANY ROOMS USED FOR SLEEPING PURPOSES; FOR DWELLING UNITS WITH MULTIPLE LEVELS, WHEN ANY LEVEL HAS ONLY ONE MEANS OF EGRESS, UNITS SHALL BE PROVIDED AT ALL LEVELS.

BUILDING CODE NOTES

1 ALL CONSTRUCTION WORK SHALL BE DONE IN ACCORDANCE WITH REQUIREMENTS OF THE FOLLOWS:

-2020 RESIDENTIAL CODE(RC) CODE OF NEW YORK STATE -2020 ENERGY CONSERVATION CONSTRUCTION CODE OF NEW YORK STATE (ECCCNYS) -2020 EXISTING BUILDING CODE OF NEW YORK STATE -SOUTHOLD TOWN CODE

- PER RC OF NEW YORK STATE R102.7.1 ADDITIONS, ALTERATIONS OR REPAIRS TO ANY STRUCTURE SHALL CONFORM TO THE REQUIREMENTS FOR A NEW STRUCTURE WITHOUT REQUIRING THE EXISTING STRUCTURE TO COMPLY WITH THE REQUIREMENTS OF THE CODE. ADDITIONS, ALTERATIONS, REPAIRS AND RELOCATIONS SHALL NOT CAUSE AN EXISTING STRUCTURE TO BECOME UNSAFE OR ADVERSELY AFFECT THE PERFORMANCE OF THE BUILDING.
- 3 ALL ELECTRICAL WORK TO CONFORM TO LOCAL, STATE, AND N.E.C. AND UNDERWRITERS REQUIREMENTS. 4 ALL PLUMBING TO CONFORM TO LOCAL AND STATE CODES AND HEALTH DEPARTMENT REQUIREMENTS.
- 5 ALL FRAMING TO CONFORM THE INTERNATIONAL BUILDING CODE, FOR HIGH WIND ZONE 3, 120 MPH, 3 SECOND GUST. SITE EXPOSURE B. ALL FRAMING HARDWARE TO BE SIMPSON STRONG-TIE WITH A CONTINUOUS LOAD TRANSFER PATH FROM THE RAFTERS TO THE FOUNDATION. SHEATHING MUST BE NAILED TO TOP PLATE, OTHER PLATES, ALL STUD AND HEADERS, ROOF RAFTERS TO BE CLIPPED ACROSS THE PLATE TO THE STUD.
- 6 REQUIRED INSPECTIONS:

-FOOTING AND FOUNDATION INSPECTION -FRAMING AND ROUGH-IN INSPECTION -PLUMBING ROUGH-IN INSPECTION -GAS ROUGH-IN INSPECTION -MECHANICAL ROUGH-IN INSPECTION -ELECTRICAL INSPECTION -FINAL INSPECTION

7 THE CONTRACTOR SHALL NOTIFY THE CODE OFFICIAL WHEN WORK IS READY FOR INSPECTION, AND SHALL PROVIDE ACCESS TO AND MEANS FOR INSPECTIONS.

ENERGY CODE NOTES

- 1 (U.O.N., ALL CODE SECTIONS REFERENCED REFER TO 10 ECCCNYS)
- 2 TO THE BEST OF MY KNOWLEDGE, BELIEF AND PROFESSIONAL JUDGEMENT, THESE PLANS AND SPECIFICATIONS ARE IN COMPLIANCE WITH THE ENERGY CONSERVATION CONSTRUCTION CODE OF NEW YORK STATE (ECCCNYS)
- 3 ALSO SEE THE ENERGY CODE ANALYSIS CHART.
- 4 ALL ALTERATIONS WORK SHALL COMPLY WITH 2020 NYSECCC.
- 5 PER ECCCNYS SECTION R503.1, ALTERATIONS SHALL CONFORM TO ENERGY CODE REQUIREMENTS WITHOUT REQUIRING THE UNALTERED PORTIONS OF THE EXISTING BUILDING OR EXISTING SYSTEM TO COMPLY. ALTERATIONS SHALL NOT CREATE AN UNSAFE OR HAZARDOUS CONDITION OR OVERLOAD EXISTING BUILDING SYSTEMS. ALTERATIONS SHALL BE SUCH THAT THE EXISTING BUILDING USES NOT MORE ENERGY THAN PRIOR TO
- 6 PER 907.1 OF EXISTING BUILDING CODE OF NEW YORK STATE, LEVEL 3 ALTERATIONS TO EXISTING BUILDINGS OR STRUCTURES ARE PERMITTED WITHOUT REQUIRING THE ENTIRE BUILDING OR STRUCTURE TO COMPLY WITH THE ENERGY REQUIREMENTS OF THE ECCCNYS. THE ALTERATIONS SHALL CONFORM TO THE ENERGY REQUIREMENTS OF THE ECCCNYS AS THEY RELATE TO NEW CONSTRUCTION ONLY.
- 7 PER R106, REQUIRED ENERGY CODE INSPECTIONS INCLUDE:
- -FRAMING AND ROUGH-IN INSPECTION -PLUMBING AND ROUGH-IN INSPECTION
- -MECHANICAL AND ROUGH-IN INSPECTION
- -FINAL INSPECTION
- 8 THE CONTRACTOR SHALL NOTIFY THE CODE OFFICIAL WHEN WORK IS READY FOR INSPECTION, AND SHALL PROVIDE ACCESS TO AND MEANS FOR INSPECTIONS.
- 9 PER R303.1.1. AN R-VALUE IDENTIFICATION MARK SHALL BE APPLIED BY THE MANUFACTURER TO EACH PIECE OF BUILDING THERMAL ENVELOPE INSULATION THAT IS 12 INCHES OR GREATER IN WIDTH, ALTERNATELY, THE INSULATION INSTALLERS SHALL PROVIDE A CERTIFICATION THAT INDICATES THE TYPE, MANUFACTURER AN R-VALUE ON INSULATION INSTALLED IN EACH ELEMENT OF THE BUILDING THERMAL ENVELOPE. FOR BLOWN-IN OR SPRAYED FIBERGLASS AND CELLULOSE INSULATION, THE INITIAL INSTALLED DENSITY, COVERAGE AREA AND NUMBER OF BAGS INSTALLED SHALL BE INDICATED ON THE CERTIFICATION. FOR SPRAYED POLYURETHANE FOAM(SFP) INSULATION, THE INSTALLED THICKNESS SHALL BE INDICATED ON THE CERTIFICATION. THE INSULATION INSTALLER SHALL SIGN, DATE AND POST THE CERTIFICATION IN A CONSPICUOUS LOCATION ON THE JOB SITE.
- 10 PER R303.1.1, AN R-VALUE MAINTENANCE INSTRUCTIONS SHALL BE FURNISHED FOR EQUIPMENT AND SYSTEMS THAT REQUIRE PREVENTIVE MAINTENANCE. REQUIRED REGULAR MAINTENANCE ACTIONS SHALL BE CLEARLY STATES AND INCORPORATED ON A READILY ACCESSIBLE LABEL. THE LABEL SHALL INCLUDE THE TITLE OR PUBLICATION NUMBER FOR THE OPERATION AND MAINTENANCE MANUAL FOR THAT PARTICULAR MODEL AND TYPE OF PRODUCT.
- 11 THE PERMANENT CERTIFICATE RE ENERGY EFFICIENT SHALL BE COMPLETED BY THE BUILDER OR OTHER APPROVED PARTY AND POSTED PER THE REQUIREMENTS OF ECCCNYS R401.3.
- 12 AT CEILINGS WITHOUT ATTIC SPACES, R VALUE OF ROOF / CEILING INSULATION MAY BE REDUCED TO R-30 AS PER R402.2.2 AND LIMITATIONS SET FORTH IN THAT SECTION.
- 13 PER R402.4.5. RECESSED LUMINAIRES INSTALLED IN THE BUILDING THERMAL ENVELOPE SHALL BE SEALED TO LIMIT AIR LEAKAGE BETWEEN CONDITIONED AND UNCONDITIONED SPACES, AND SHALL BE IC-RATED AND LABELED AS HAVING AND AIR LEAKAGE OF NOT GREATER THAN 2.0 CFM WHEN TESTED IN ACCORDANCE WITH ASTM E283 AT A PRESSURE DIFFERENTIAL OF 1.57 PSF. RECESSED LUMINAIRES SHALL BE SEALED WITH A GASKET OR CAULKED BETWEEN THE HOUSING AND THE INTERIOR WALL OR CEILING COVERING.

ENERGY CODE ANALYSIS

ELECTRICAL POWER AND LIGHTING SYSTEMS

THE CHART DEMONSTRATES COMPLIANCE OF THIS PROJECT WITH APPLCIABLE REQUIREMENTS OF THE 2020 ENERGY CONSERVATION CONSTRUCTION CODE OF NEW YORK STATE(ECCCNYS) (U.O.N. ALL CODE SECTIONS REFRENCED REFER 10 BUILDING TYPE: RESIDENTIAL

CLIMATE ZONE: 4A COMPLIANCE: PRESCRIPTIVE - SECTIONS R401 THROUGH R404

ITEM DESCRIPTION	PROPOSED VALUE	ECCCNYS PRESCRIBED VALUE
CEILING/ ROOF R-VALUE	R-54 (6" CLOSED CELL INSULATION (R-6.5/INCH) + R-15 COMFORT BATT INSULATION) PER TABLE R402.1.2, MN.49
WOOD FRAME WALL R-VALUE	R-26.6 (R-23 ROCKWOOL INSULATION + R SHEATHING (R-3.6))	PER TABLE R402.1.2, MN. R-20 CAVITY OR R-13 (CAVITY) + R-5 (CONTINUOUS)
FLOOR R-VALUE	R-21	PER TABLE R402.1.2, MN. R-19
CRAWL SPACE WALL R-VALUE	R-13	R-13
	FENESTRATION U-FACTOR; MAX U-0.32	PER TABLE R402.1.2, FENESTRATION U-FACTOR; MAX U-0.32
FENESTRATION U-FACTOR AND SOLAR HEAT GAIN	GLAZED FENESTRATION SHGC; MAX. SHGC 0.40	PER TABLE R402.1.2, GLAZED FENESTRATION SHGC; MAX. SHGC 0.40
AIR LEAKAGE	WHERE APPLICABLE AT AREAS OF NEW WORK, THE BUILDING THERMAL ENVELOPE SHALL COMPLY WITH R402.4 AIR LEAKAGE AND CRITERIA AS INDICATED IN TABLE R402.4.1.1. JOINTS, PENETRATIONS, SEAMS, CONNECTIONS TO BE SEALED, WRAPPED CAULKED, GASKETED, TAPED IN APPROVED MANNER TO MINIMIZE AIR LEAKA	PER TABLE R402.4: THE BUILDING THERMAL ENVELOPE SHALL LIMIT AIR LEAKAGE IN ACCORDANCE WITH REQUIREMENTS OF SECTION R402.4, A CRITERIA INDICATED IN TABLE R402.4.1.1
	WINDOWS, SKYLIGHTS AND SLIDING DOORS SHALL HAVE AN AIR INFILTRATION RATE OF NOT GREATER THAN 0.3 CFM PER SQUARE FOOT.	PER TABLE R402.4.3; WINDOWS, SKYLIGHTS AND SLIDING DOORS SHALL HAVE AN AIR INFILTRATION RATE OF NOT GREATER THAN 0.3 CFM PER SQUARE FOOT. AND FOR SWINGING DOORS SHALL HAVE AN AIR LEAKAC
FENESTRATION AIR LEAKAGE	SWINGING DOORS SHALL HAVE AN AIR LEAKAGE OF NOT GREATER THAN 0.5 CFM PER SQUARE FOOT	OF NOT GREATER THAN 0.5 CFM PER SQUARE FOOT, WHEN TESTED IN ACCORDANCE WITH NFRC 400 OR AAMA/WDMA/CSA101/LS.2/A440 BY AN ACCREDITED, INDEPENDENT LAB, AND LISTED AND LABELED BY THE
	WHEN TESTED AS NOTED IN THE NEXT COLUMN ->	MANUFACTURER
	NOT LESS THAN 60% OF NEW DEDMANENTLY INSTALLED HOLITING FIVEHIDES SHALL	DED DAGA 4. NOT LEGG THAN 600% OF NEW DEDMANIENTLY INCTALLED

LIGHTING FIXTURES SHALL CONTAIN ONLY HIGH-EFFICACY LAMPS

CONTAIN ONLY HIGH-EFFICACY LAMPS.

225 MONSELL PLACE

ISSUE/REVISION

CONSULTANTS

ARCHITECT

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STRUCTURAL ENGINEER

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MECHANICAL ENGINEER

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A/V + IT CONSULTANT

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ACOUSTICAL CONSULTANT

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CONSULTANT 6 TYPE

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CONSULTANT 7 TYPE XXXX XXXX

XXXX XXXX

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DRAWING TITLE

GENERAL NOTES

16090	SHT. NO.:	001
G TEFAN TURE THE	SCALE:	
REDAR	DATE:	01/08/20
STAMP & SIGNATURE	PROJ. NO.:	2018

ANNOTATION SYMBOLS LEGEND INTERIOR ELEVATION MARKER

A101

EXTERIOR ELEVATION MARKER

Room name 101

ROOM TAG

SECTION HEAD

ENALRGED AREA CALLOUT

TOP OF SLAB

ELEVATION / DATUM MARKER

DRAWING TITLE

830 DOOR TAG

CENTERLINE

 $\langle 1i \rangle$

1

FIN.

FIN. FL.

FL. DR.

FLASH.

FOUND.

FYR.

FIXT.

FINISH (ED)

FINISH FLOOR

FLOOR DRAIN

FLASHING

FOYER

FOUNDATION

FIXTURE

FLOOR


WINDOW TAG

PARTITION TAG


FINISH TAG

REVISION TAG

MATERIAL LEGEND

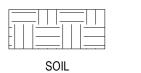




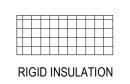








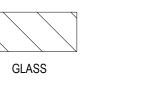




WOOD PLANK



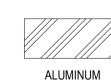



STEEL

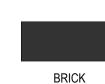

REVIATIONS LIST	

AIR CONDITIONER UNIT A.C., A/C A.C.T. ACOUSTIC CEILING TILE A.D. AREA DRAIN A.F.F. ABOVE FINISH FLOOR AS NOTED A.N. ADJ. ADJACENT ADJUST ADJUSTABLE ALUM. ALUMINUM APT. APARTMENT BATH B. CAB. BASE CABINET B.C. **BRICK COURSES** B.F. **BOILER FLUE** B.O.S. BOTTOM OF SLAB B.R. BEDROOM B.S.A. BOARD OF STANDARDS AND APPEALS B.T. BATHTUB B.V. (B.E.) BATH VENT (BATH EXHAUST) BOARD BLDG. BUILDING BLK. **BLOCK** BM. BEAM BOT. BOTTOM BRICK BTW. BETWEEN C. CJ. CAULKED CONTROL JOINT C. JT. CAULK JOINT C.H. CONCRETE HARDENING C.I.S. CAST IRON SADDLE C.J. CONTROL JOINT C.L.L. CONTRACT LIMIT LINE C.M.T. CORRUGATED METAL TIE C.O. CLEAN OUT C.R. CEILING REGISTER C.S. CAST STONE C.T. CERAMIC TILE C.W. COLD WATER CAB. CABINET CAULK. CAULKING CEM. CEMENT CH. CHAMBER

CLOSET

CEILING

COLUMN

CONCRETE

CONTINOUS

CONVECTOR

CORRIDOR

COUNTER

CARPET

COURSE

DELIVERED FINISHED

CONCRETE MASONRY UNITS

CLG.

CMU

COL.

CONC

CONT.

CONV

CORR.

COUNT.

CPT.

CRS.

D.F.

ABBREVIATIONS LIST DOUBLE LAYER D.L. D.R. DINING ROOM D.U. DWELLING UNIT D.W. DISHWASHER DET. DETAIL DIA. DIAMETER DIAG. DIAGONAL DIM. DIMENSION DIR. DIRECTIONAL DIV. DIVIDER DN. DOWN DR. DOOR. DRN. DRAIN DWG. DRAWING DX DRYER EXHAUST EIK EAT IN KITCHEN ELEC. ELECTRIC(AL) ELEC. HT. ELECTRIC HEATER ELEC. MET. **ELECTRIC METER** ELEV. **ELEVATOR** ENAM. PT. **ENAMEL PAINT** EQ. EQUP. **EQUIPMENT** EST. GD. ESTABLISHED GRADE EXIT **EXIT SIGN** EXIT LT. EXIT LIGHT EXP. **EXPANSION** EXP. CONC. EXPOSED CONCRETE EXP. JT. EXPANSION JOINT EXT. **EXTERIOR** F. EX. FIRE EXTINGUISHER F. HT. FULL HEIGHT F. RT. FIRE RATING F.A. INT. FRESH AIR INTAKE F.B. FACE BRICK F.F.B.D. FULL FALSE BEAM DROP F.F.EL. FINISH FLOOR ELEVATION F.H.M. FLUSH HOLLOW METAL F.O. FLUSH OPENING F.P. FIRE PROOF F.P.C. FACTORY PRIME COAT F.P.H.B. FROSTPROOF HOSE BIBB F.P.S.C. FIREPROOF SELF-CLOSING F.P.W.G. FIREPROOF WIRE GLASS F.S.P. FIRE STANDPIPE FFE FURNITURE FITTINGS EQUIPMENT

G.B.

M.O.

M.T.

M.W.

MAINT.

MAS.

ABBREVIATIONS LIST GRAB BAR G.B.F.B. GYPSUM BOARD FURRED BEAM G.B.H.C. GYPSUM BOARD HUNG CEILING G.B.T.O. GYPSUM BOARD TRIMMED OPENING G.C. GENERAL CONTRACTOR G.E.P. GLOSS ENAMEL PAINT GA. GAUGE GALV. GALVANIZED GEN. **GENERAL** GLASS GL. GR. GRADE GRB. CH. GARBAGE CHUTE GWB GYPSUM WALLBOARD GYP. **GYPSUM** GYP. BD. DRYWALL CONSTRUCTION H.B. HOSE BIB H.C. HUNG CEILING H.M. HOLLOW METAL H.P. HIGH POINT H.R. HAND RAIL H.V. HALL VENT (DUCT) H.W. HOT WATER HEIGHT HVAC HEATING, VENTILATION, AIR CONDITIONING I.D. INSIDE DIAMETER INSULATED GYPSUM BOARD CEILING I.G.B.C. INCL. INCLUDED, INCLUDING INSUL. INSULATION INT. INTERIOR JAN. CL. JANITOR CLOSET JOINT KITCHEN KITTE KITCHENETTE KX KITCHEN EXHAUST L.D. LOUVER DOOR L.L.A. LOOSE LINTEL ABOVE L.P. LOW POINT L.R. LIVING ROOM LAM. LAIMINATED LAM. PL. LAIMINATED PLASTIC LAV. LAVATORY LDR. LEADER LIBRARY LIN. CL. LINEN CLOSET LT. WT. LIGHTWEIGHT M.B. MASTER BATHROOM M.E.A. MATERIAL & EQUIPMENT ACCEPTANCE DIV. METAL LINED M.L.V. METAL LOUVER VENT

MASONRY OPENING

MECHANICAL WATERPROOFING

MAINTAIN, MAINTENANCE

MEN'S TOILET

MASONRY

MAXIMUM

ABBREVIATIONS LIST

MARBLE SADDLE MB. SDL. MBR MASTER BEDROOM MECH. MECHANICAL MET. METAL MIN. MINIMUM MISC. MISCELLANEOUS MSNRY. MASONRY MTD. MOUNTED N.C. NON-CORROSIVE N.H.C. NO HUNG CEILING N.I.C. NOT IN CONTRACT N.T.S. NOT TO SCALE NO. (#) NUMBER NOM. NOMINAL O.C. ON CENTER O.D. OUTSIDE DIMENSION O.F. **OVERFLOW** O.H. OPPOSITE HAND O.T.B. OPEN TO BELOW OPEN SH. OPEN SHELF/ SHELVES OPG. OPENING OPN. CAB. OPEN CABINET OPPOSITE P.D. PUMP DISCHARGE P.H. PUBLIC HALL P.V. PUBLIC CORRIDOR VENT DUCT PART. PARTITION PC. PIECE PLANTER PL. BX. PLANTER BOX PLANTER DRAIN PL. DRN. PLY. D. PLYWOOD DIVIDER POL. POLISHED PRIMER SEALER PR. SLR. PREMOLDED FILLED PRMD. FIL. PT. PTD. PAINTED PWDR. POWDER ROOM ROOM R.D. **ROOF DRAIN** R.H. RANGE HOOD R.W. RETAINING WALL RAD. RADIATOR, RADIUS REC. RECESSED REF. REFRIGERATOR RESIL. RESILIENT RECESSED HAMPER RM. ROOM SINK

SLEEPING AREA

SLAB OPENING

SPRAY ON PAINT

SMOKE ACTIVATED DOOR

SIMULATED ACCOUSTICAL PAINT

SOUND TRANSMISSION CLASSIFICATION

SOUND INSULATED PARTITION

S.A.D.

S.A.P.

S.I.P.

S.O.

S.O.P.

S.T.C.

ABBREVIATIONS LIST

ABBREVIATIONS LIST

W/D

W/O

WD.

WHRL.

WHRL. A.P.

WIND. DIM.

WL. CAB.

WR. GL.

WTR. RES.

WITH

WITHOUT

WHIRLPOOL

WOOD

WASHER / DRYER

WHIRLPOOL ACCESS PANEL

WINDOW DIMENSION

WASHING MACHINE

WATER RESISTANT

WALL CABINET

WIRE GLASS

S.W. SHEAR WALL SEP. SEPARATE SHOWER SHLV. SHELF, SHELVES SINGLE ROD SIN. RD. SL.S. D. SLIDING SHOWER DOORS SPRLK. SPRINKLER ST. STL. STAINLESS STEEL STAT. STATIONARY STL. STEEL STL. SD. STEEL SADDLE STOR. STORAGE STR. JTS. STRUCTURAL JOINTS SURFACE MOUNTED SURF. MTD. SV CL. SERVICE CLOSET SV. EL. SERVICE ELEVATOR T.C. TOP OF COPING T.F.O. TOP FLOOR ONLY T.O. TRIMMED OPENING T.O.C. TOP OF CURB T.O.S. TOP OF SLAB T.O.W. TOP OF WALL T.R. TOP REGISTER TEMP. TEMPERED TERR. TERRAZZO TEX. AC. PT TEXTURED ACOUSTIC PAINT THICK TRZ. SD. TERRAZZO SADDLE TELEVISION TWL. BR. TOWEL BAR

SERVICE VENT (DUCT)

TOILET EXHAUST **TYPICAL** UNDERCUT U.C. U.O.N. UNLESS OTHERWISE NOTED URN. URNIAL V.C.B. VINYL COVE BASE V.C.J. VINYL CONTROL JOINT V.C.T. VINYL COMPOSITE TILE VINYL STRAIGHT BASE VINYL TILE

V.S.B. V.T. V.W.F. VINYL WALL FABRIC VENT. VENTILATION VEST. VESTIBULE VERIFY IN FIELD VIS. PNL. VISION PANEL W.C. WATER CLOSET WEEP HOLE WROUGHT IRON W.I.C. WALK IN CLOSET W.P. WATERPROOF WATER RESISTANT GYPSUM BOARD W.R.G.B. W.S. WEATHER STRIPPING

WOMEN'S TOILET

225 MONSELL PLACE

ISSUE/REVISION

DATE

CONSULTANTS

ARCHITECT THE TURETT COLLABORATIVE 277 BROADWAY, SUITE 1300 NEW YORK, NY, 10007 212.965.1244

STRUCTURAL ENGINEER XXXX XXXX

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MECHANICAL ENGINEER

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A/V + IT CONSULTANT

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ACOUSTICAL CONSULTANT

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CONSULTANT 6 TYPE

XXXX XXXX XXXX XXXX

CONSULTANT 7 TYPE

XXXX XXXX XXXX XXXX

THE TURETT COLLABORATIVE:

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DRAWING TITLE

SYMBOLS AND **ABBREVIATIONS**



PROJ. NO.: 2018 01/08/20 SCALE: As indicated SHT. NO.: G-002

Tax May # 1001-2-226 Existing AREA OF HOUSE + DECK = 957 SF

2,640 SF LOT AREA =

36 % LOT COVERAGE =


Proposed design AREA OF HOUSE AND DECK = 1,540 SF

LOT AREA

2,640 SF

LOT COVERAGE

58%

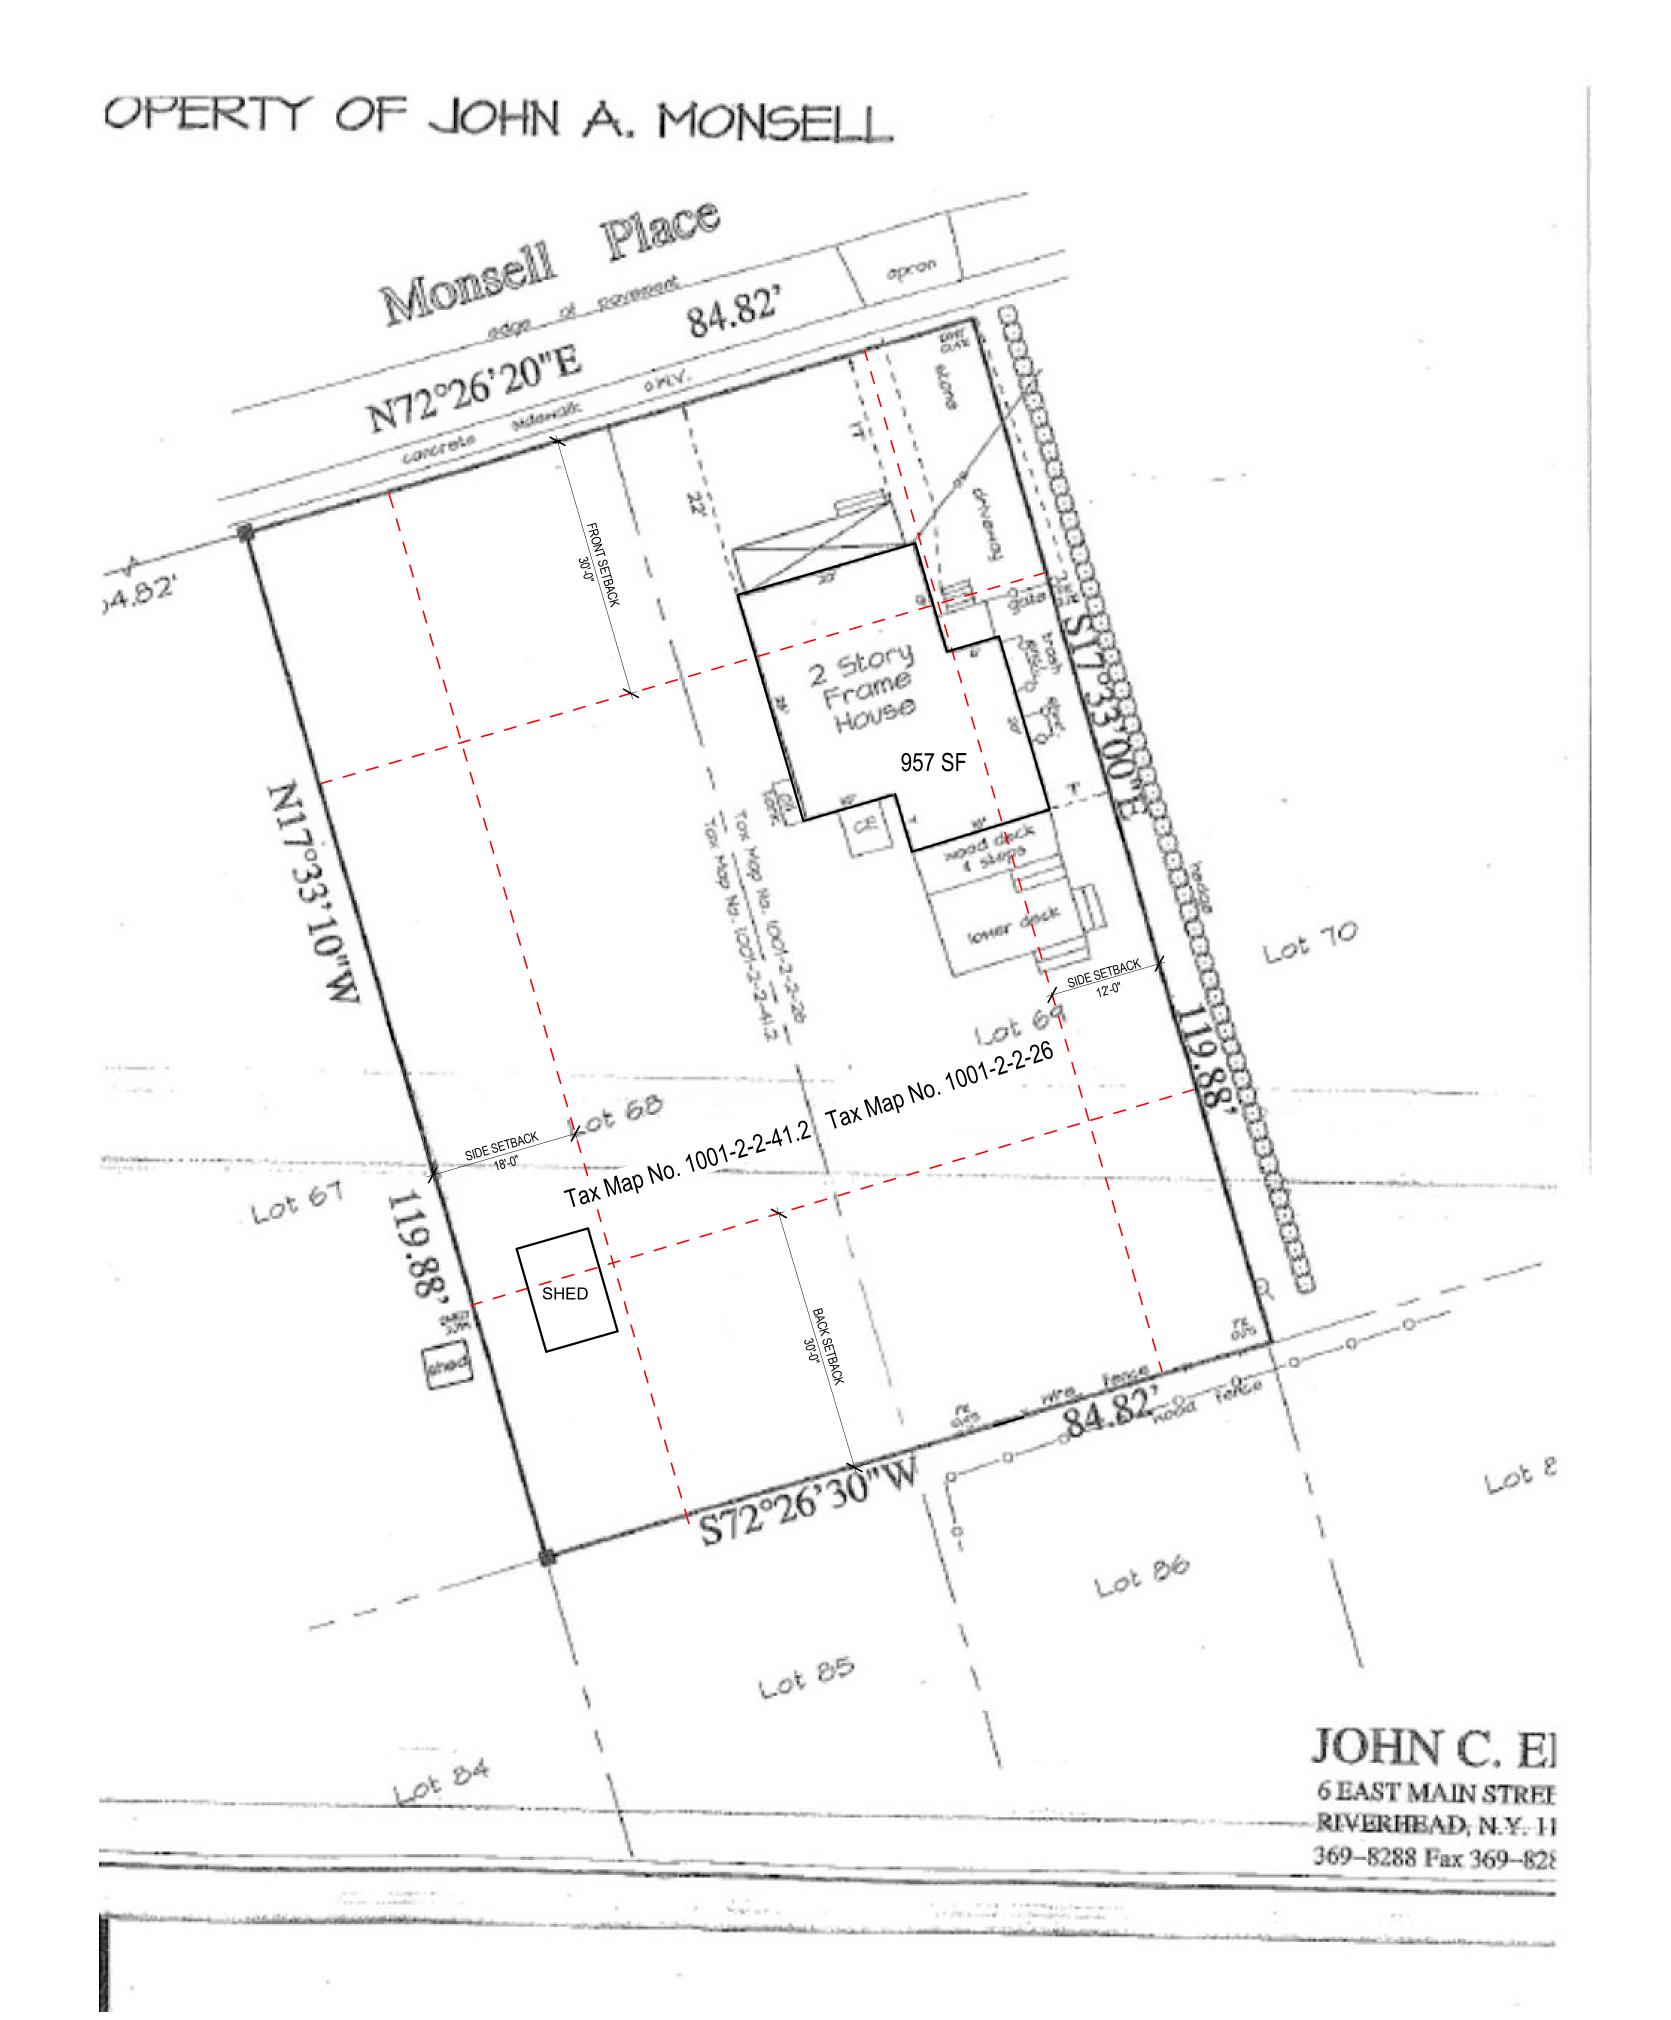



ISSUE/REVISION

2 Rev 2

04/06/22

CONSULTANTS

ARCHITECT

THE TURETT COLLABORATIVE 277 BROADWAY, SUITE 1300 NEW YORK, NY, 10007 212.965.1244

STRUCTURAL ENGINEER

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MECHANICAL ENGINEER

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A/V + IT CONSULTANT

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ACOUSTICAL CONSULTANT

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CONSULTANT 6 TYPE

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CONSULTANT 7 TYPE

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DRAWING TITLE

EXISTING SURVEY

PROJ. NO.:




BULK REQ.	ii
DISTRICT	R-1
MINIMUM REQUIREMENTS FOR 1-FAMILY DETACHED	
LOT SIZE (SQUARE FEET)	10,080
LOT WIDTH (FEET)	84
LOT DEPTH (FEET)	120
FRONT YARD (FEET)	30
SIDE YARD (FEET)	15
BOTH SIDE YARDS (FEET)	30
REAR YARD (FEET)	30
LIVABLE FLOOR AREA (SQUARE FEET PER DWELLING UNIT)	850
MAXIMUM PERMITTED DIMENSIONS:	
LOT COVERAGE (PERCENT)	11.3
BUILDING HEIGHT (FEET)	31.6
NUMBER OF STORIES	2

Existing First Floor = 874 SF Proposed First Floor = 1,142 SF

Existing Second Floor = 599 SF Proposed Second Floor = 599 SF

Existing Deck = 246 SF Proposed Deck = 398 SF

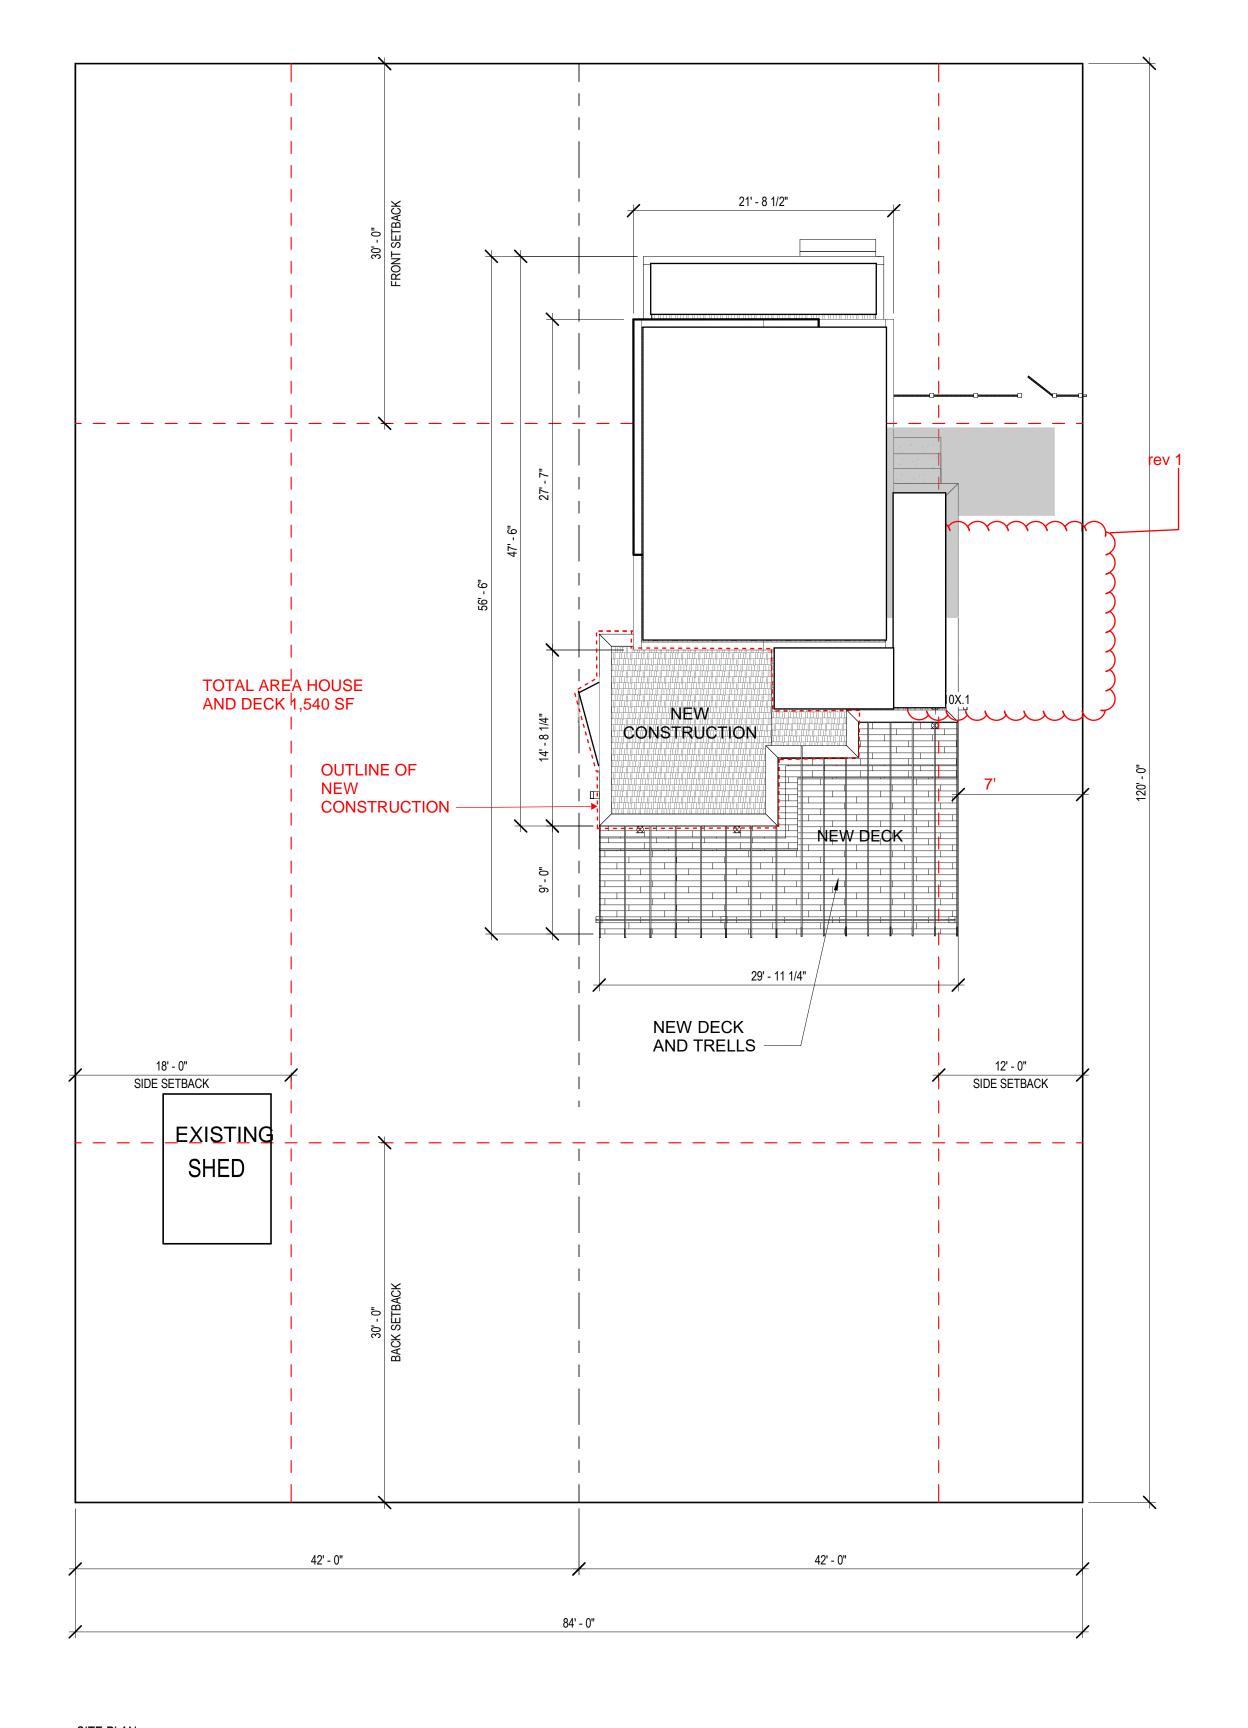

2 SITE PLAN 1/8" = 1'-0"



225 MONSELL PLACE

ISSUE/REVISION

1. deleted Bilco Dr

033022

DATE

CONSULTANTS

ARCHITECT

THE TURETT COLLABORATIVE 277 BROADWAY, SUITE 1300 NEW YORK, NY, 10007 212.965.1244

STRUCTURAL ENGINEER

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MECHANICAL ENGINEER

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A/V + IT CONSULTANT

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ACOUSTICAL CONSULTANT

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CONSULTANT 6 TYPE

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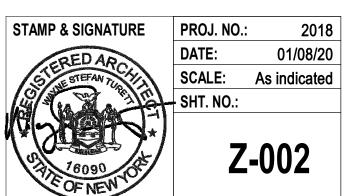
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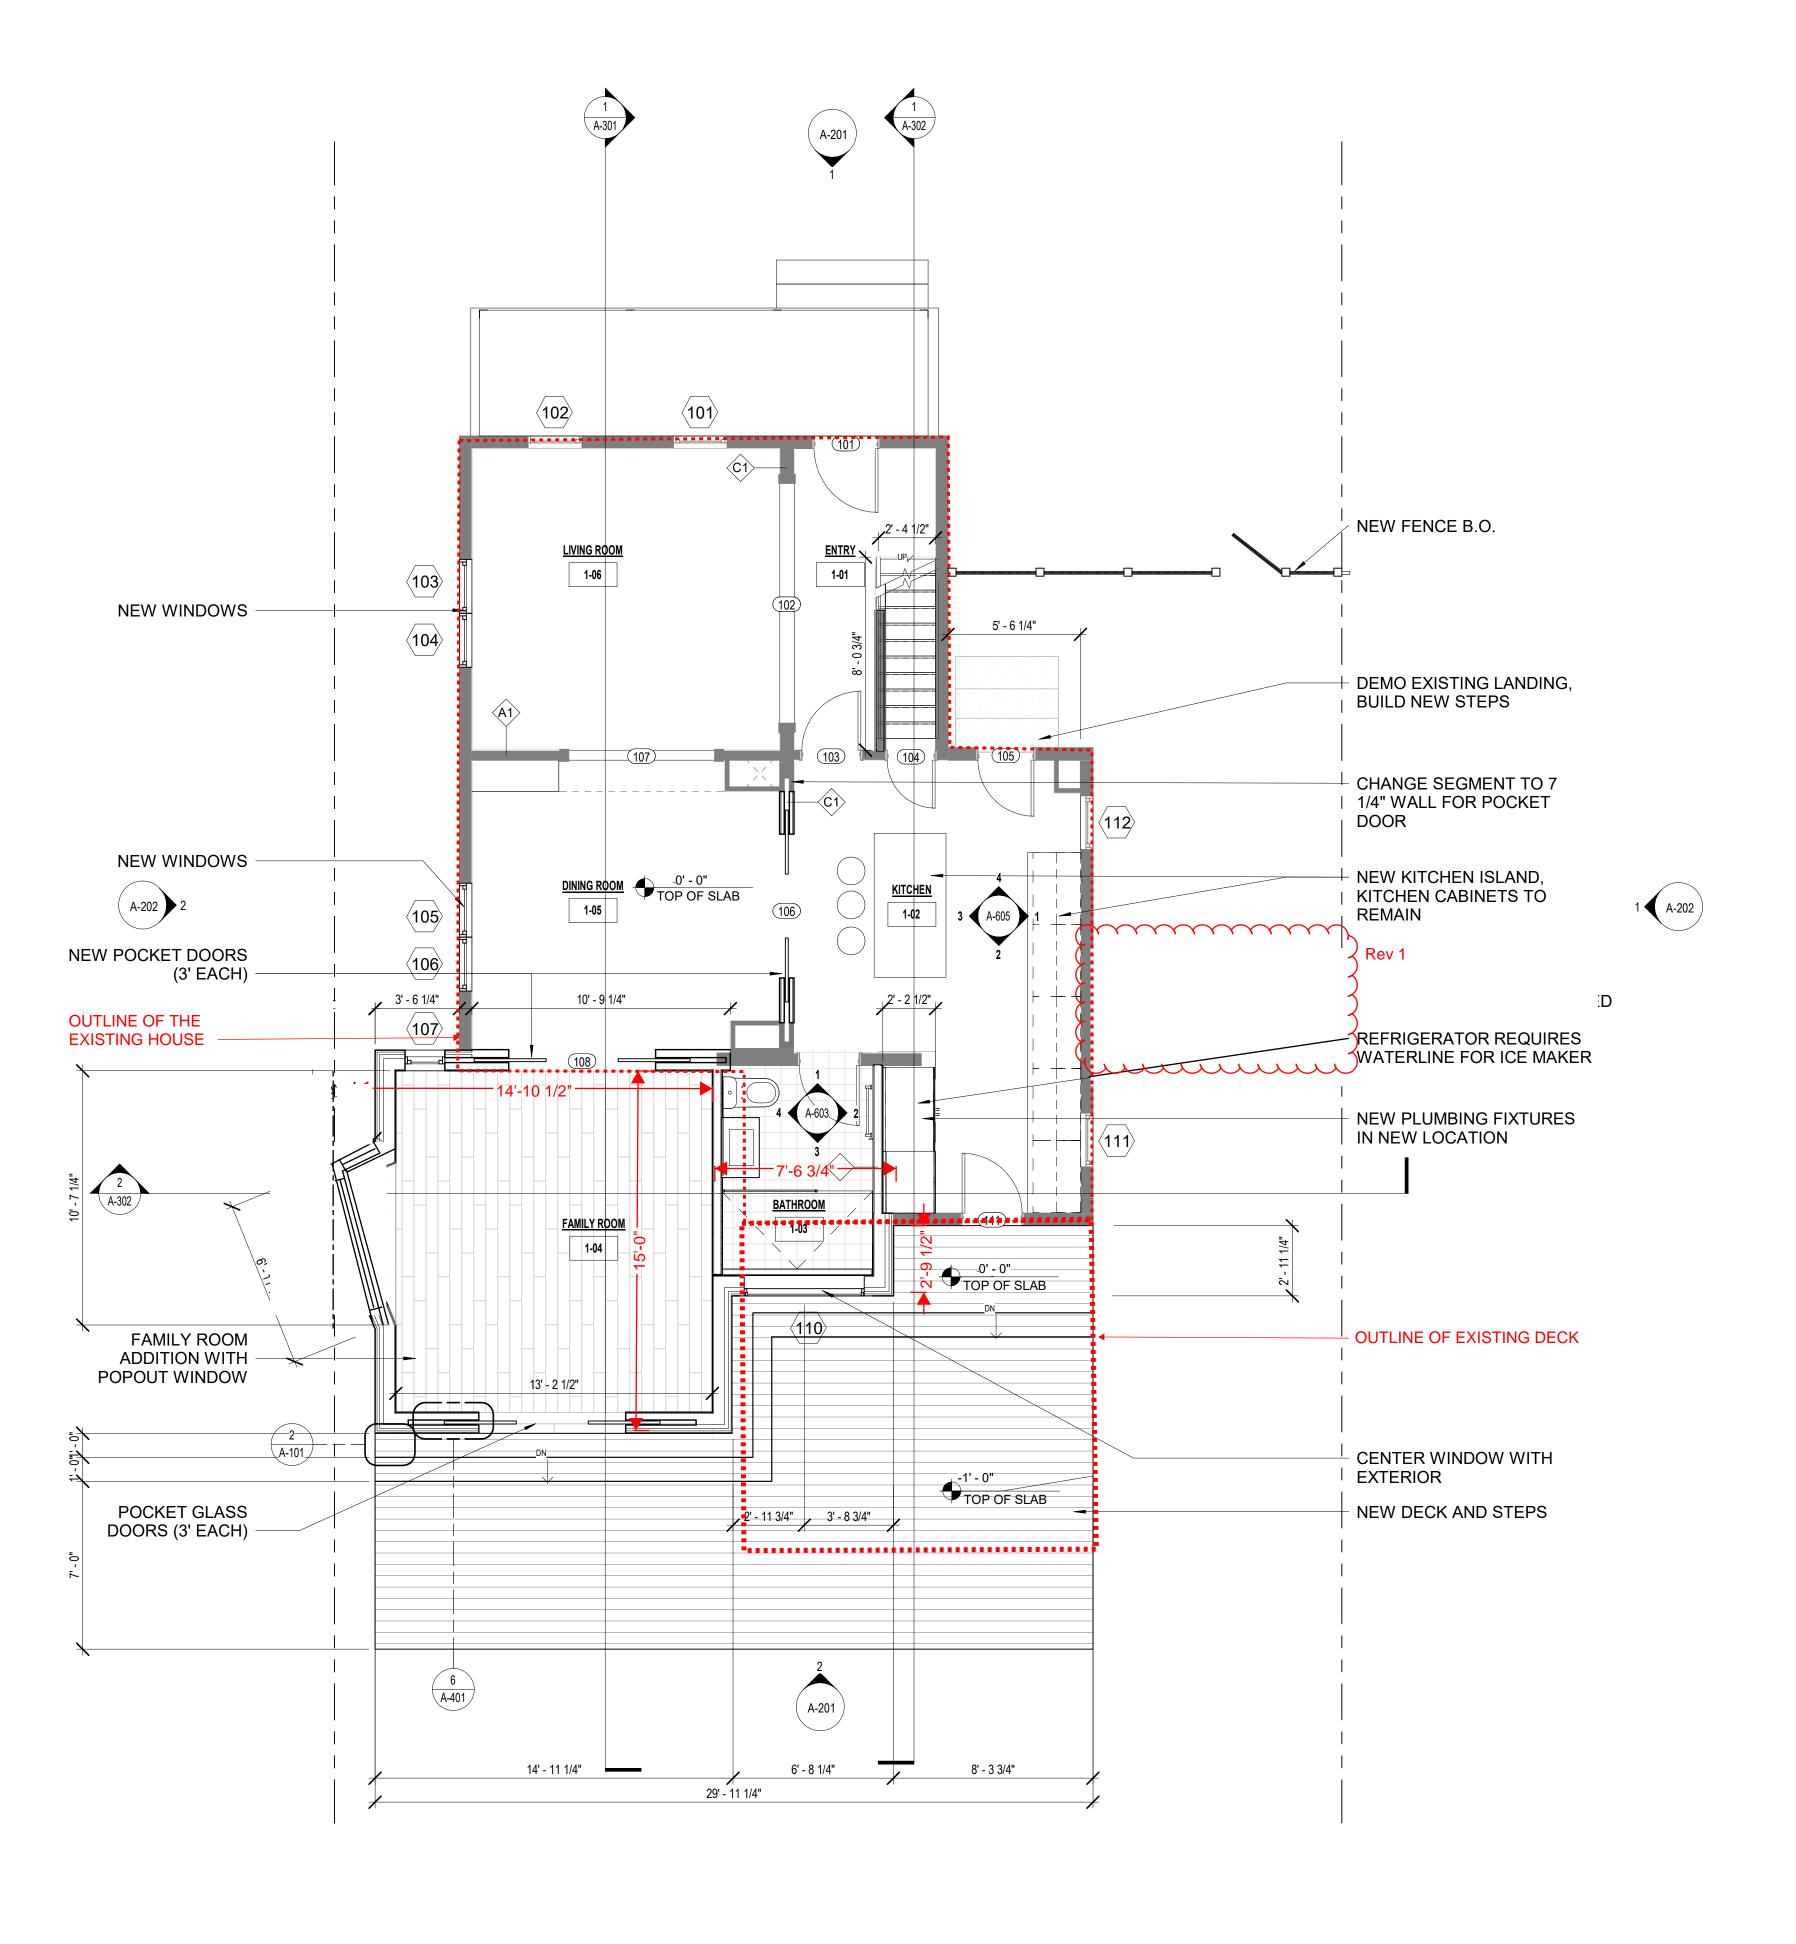
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DRAWING TITLE

NEW PROPOSED SITE PLAN





ISSUE/REVISION DATE

Rev 1 - delete Bilco door 033022

060122

Rev 2 -revised baywindow to be on one lot.

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THE TURETT COLLABORATIVE
277 BROADWAY, SUITE 1300
NEW YORK, NY, 10007
212.965.1244

STRUCTURAL ENGINEER

XXXX XXXX XXXX XXXX

MECHANICAL ENGINEER

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A/V + IT CONSULTANT

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ACOUSTICAL CONSULTANT

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CONSULTANT 6 TYPE

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CONSULTANT 7 TYPE

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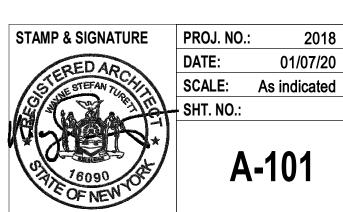
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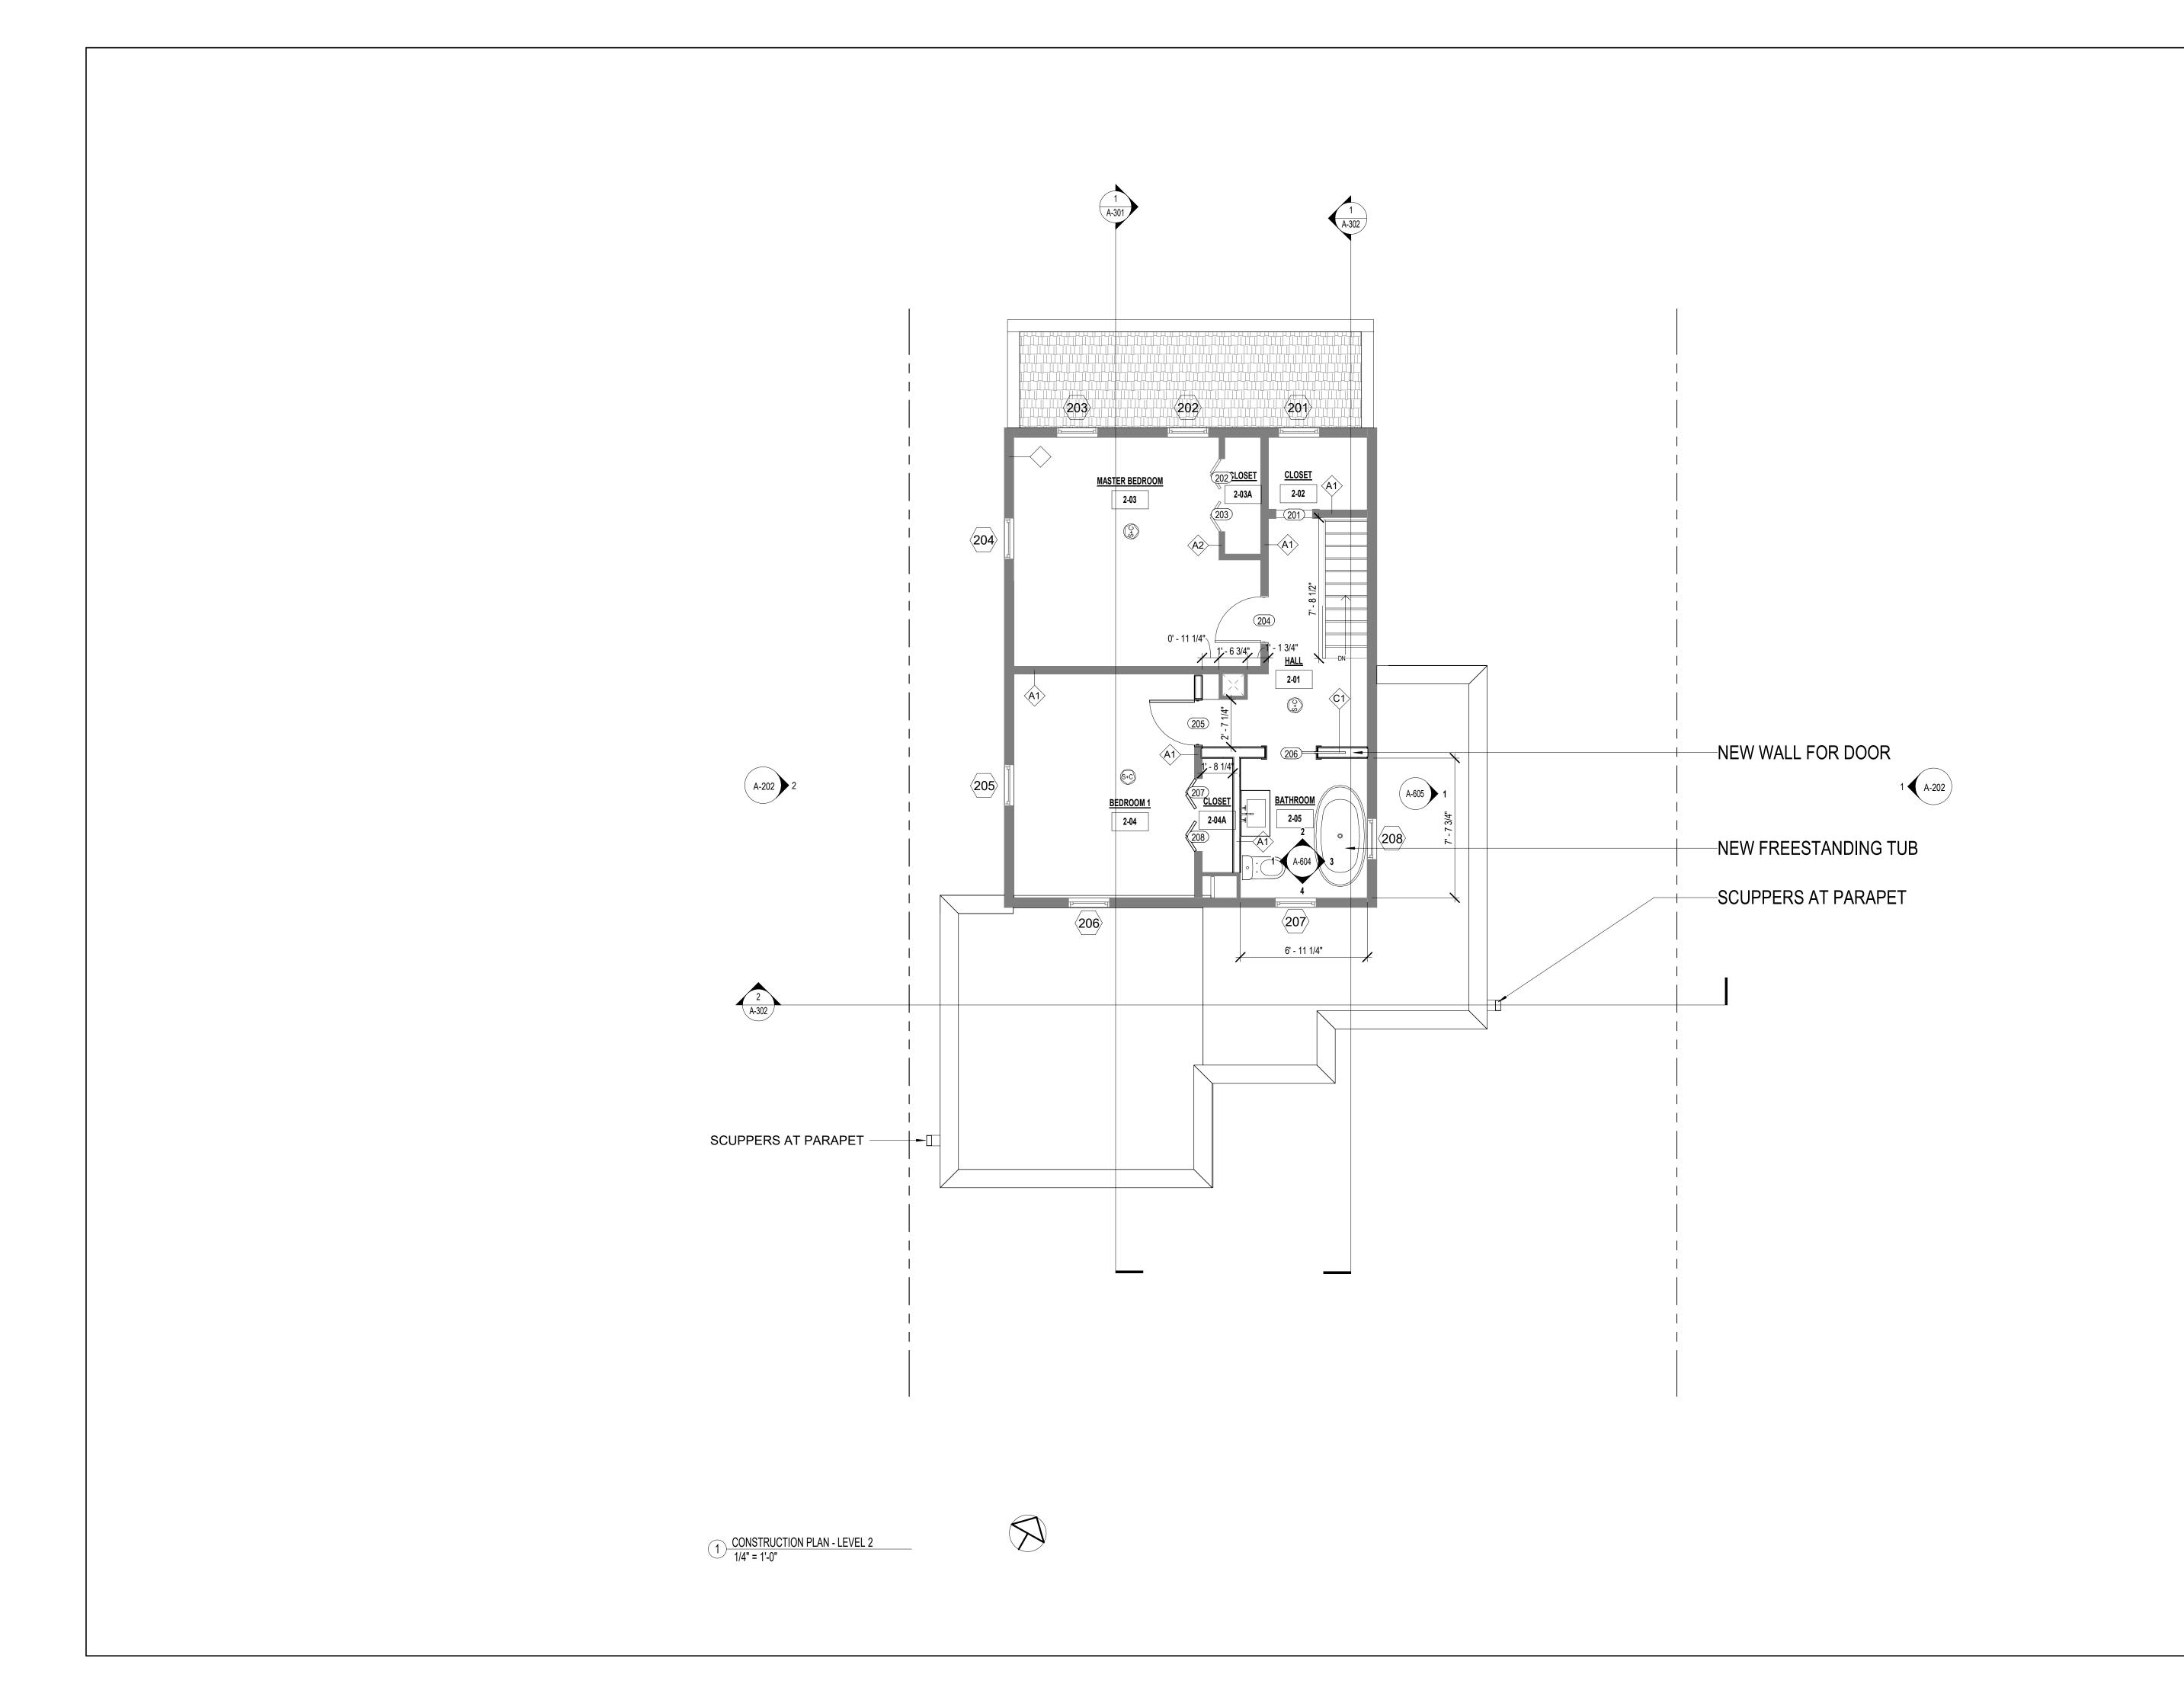
DRAWING TITLE

CONSTRUCTION PLAN -LEVEL 1



1 CONSTRUCTION PLAN - LEVEL 1
1/4" = 1'-0"

2 PLAN DETAIL - WOOD DECK 1 1/2" = 1'-0"



ISSUE/REVISION

DATE 1 Revision 1 08/04/2021

CONSULTANTS

ARCHITECT

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STRUCTURAL ENGINEER

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MECHANICAL ENGINEER

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A/V + IT CONSULTANT

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ACOUSTICAL CONSULTANT

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CONSULTANT 6 TYPE

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CONSULTANT 7 TYPE

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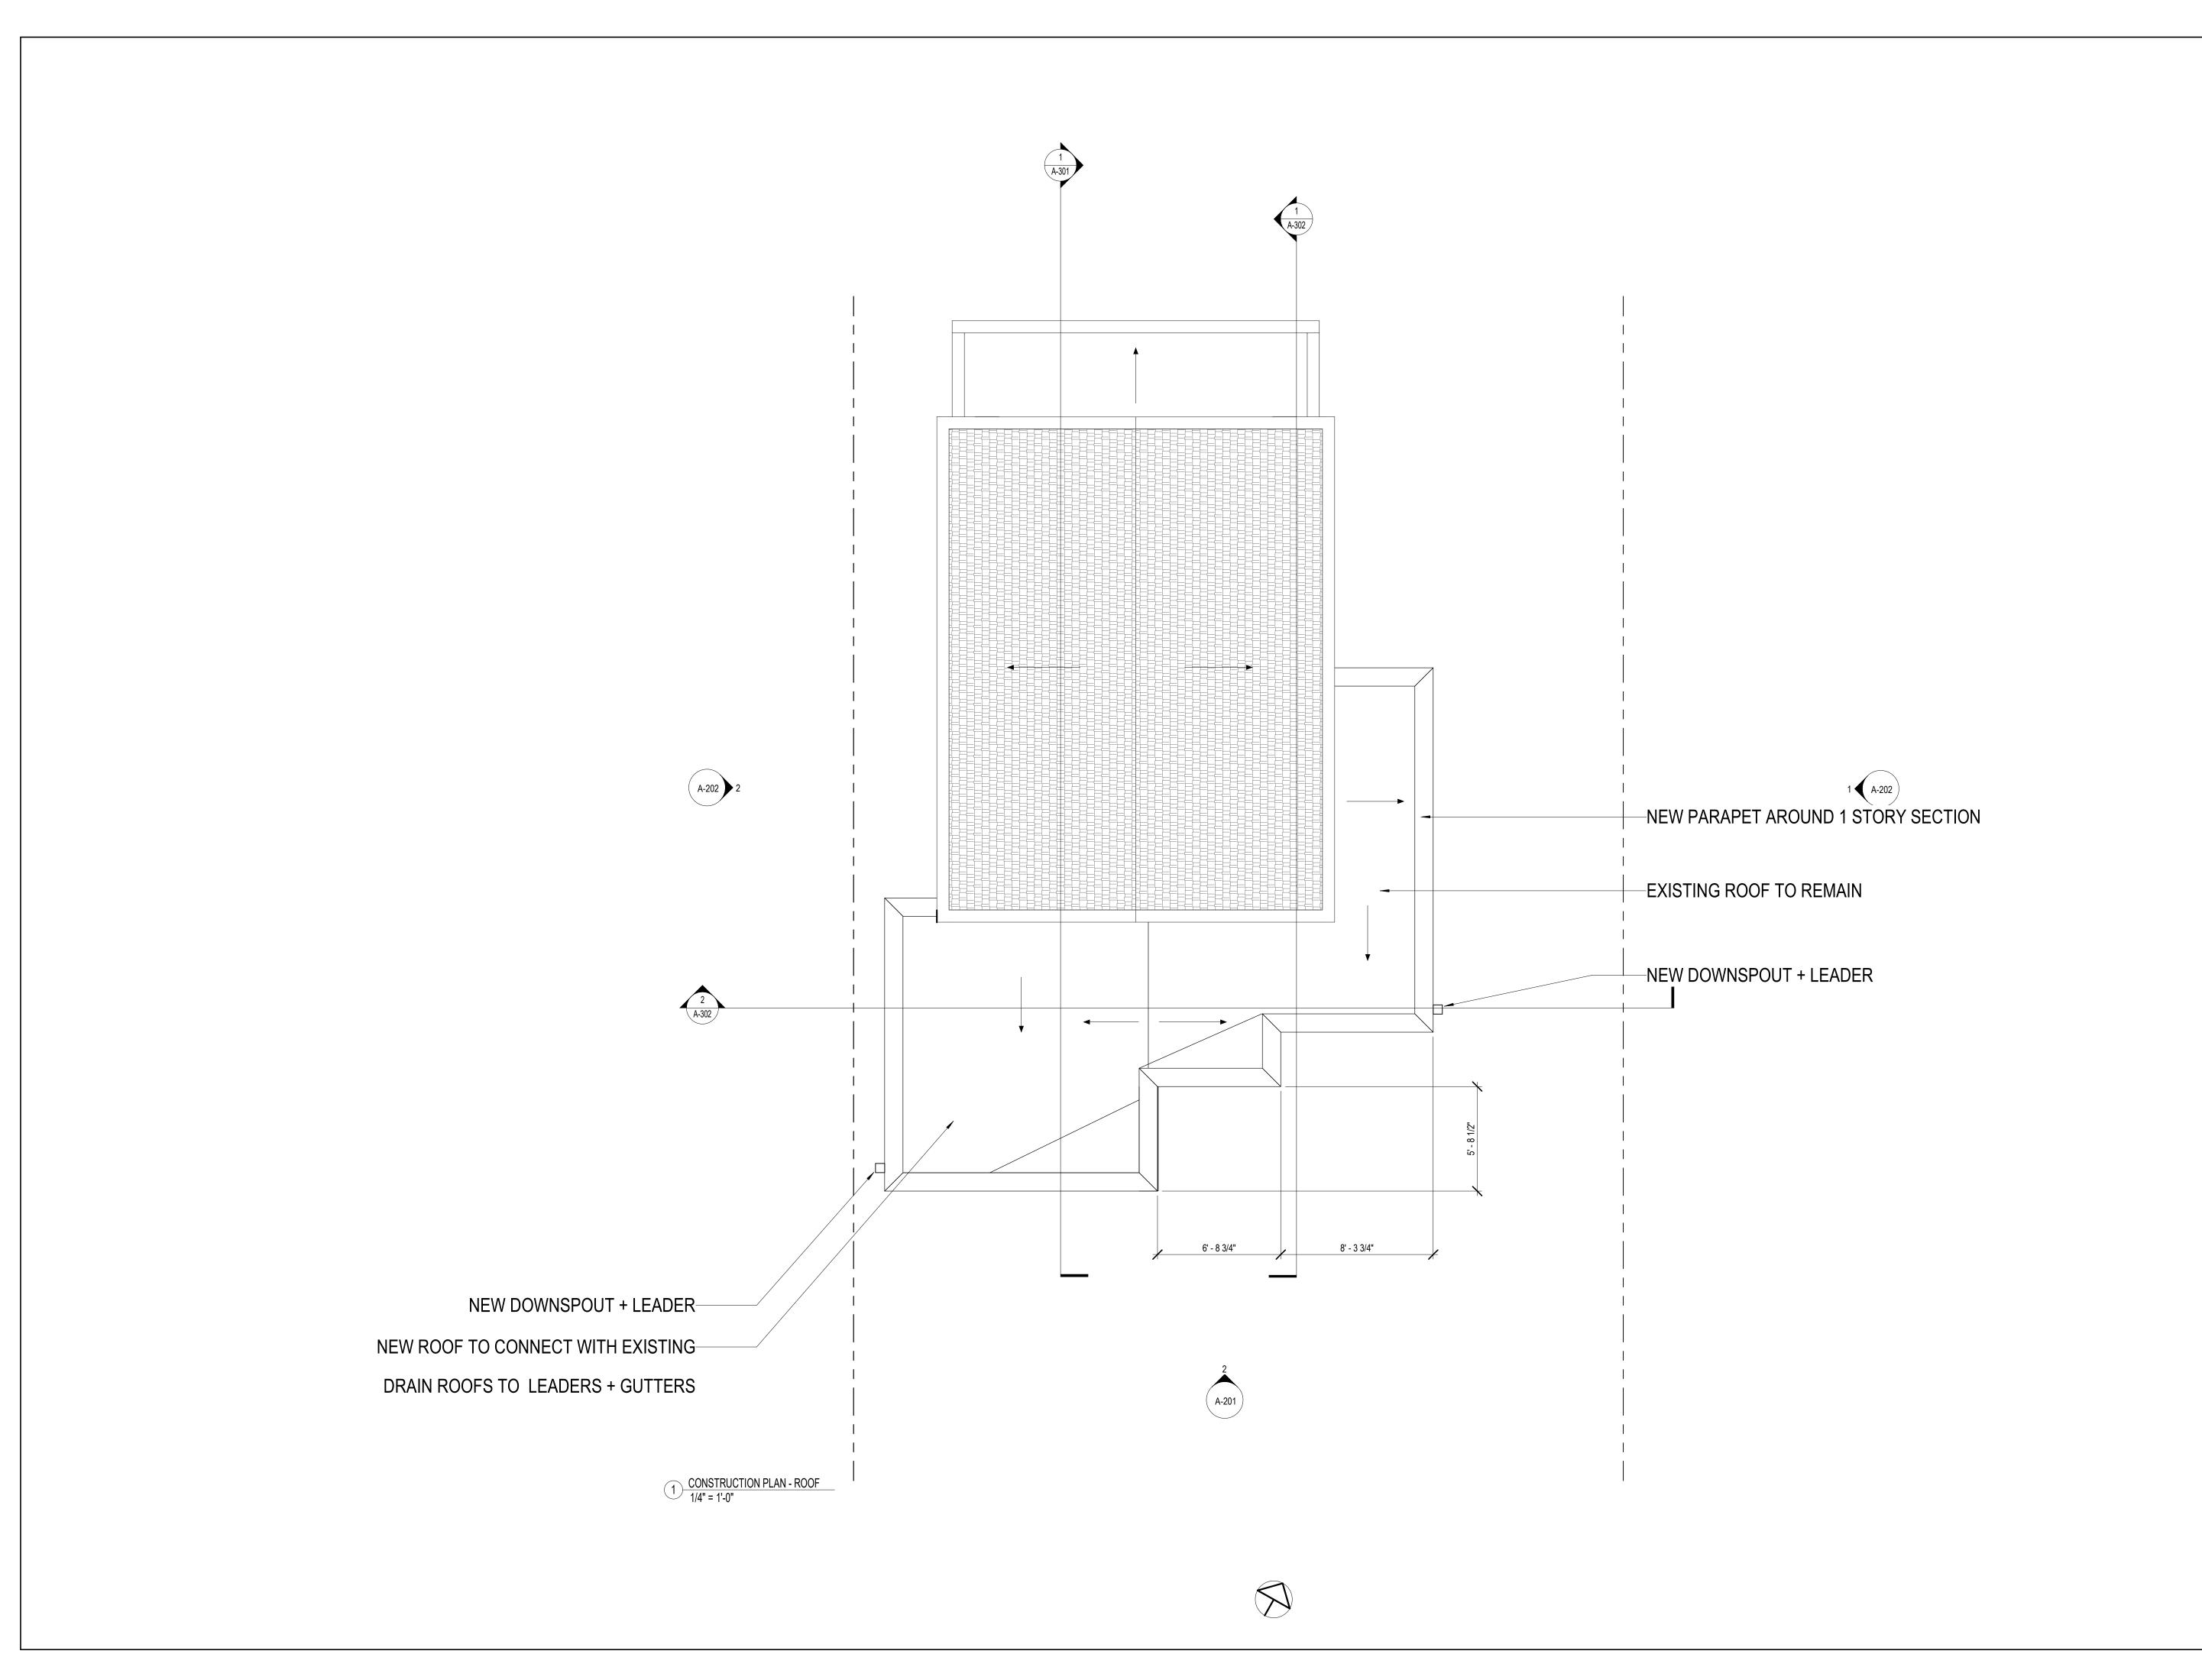
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CONSTRUCTION PLAN -LEVEL 2

STAMP & SIGNATURE PROJ. NO.:



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STRUCTURAL ENGINEER

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MECHANICAL ENGINEER

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XXXX A/V + IT CONSULTANT

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ACOUSTICAL CONSULTANT

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CONSULTANT 6 TYPE

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CONSULTANT 7 TYPE XXXX

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THE TURETT COLLABORATIVE:


277 BROADWAY STUDIO 1300 | NEW YORK, NY 10007 T: 212.965 1244 | E: INFO@TURETTARCH.COM

DRAWING TITLE

CONSTRUCTION PLAN - ROOF

STAMP & SIGNATURE PROJ. NO.: A-103



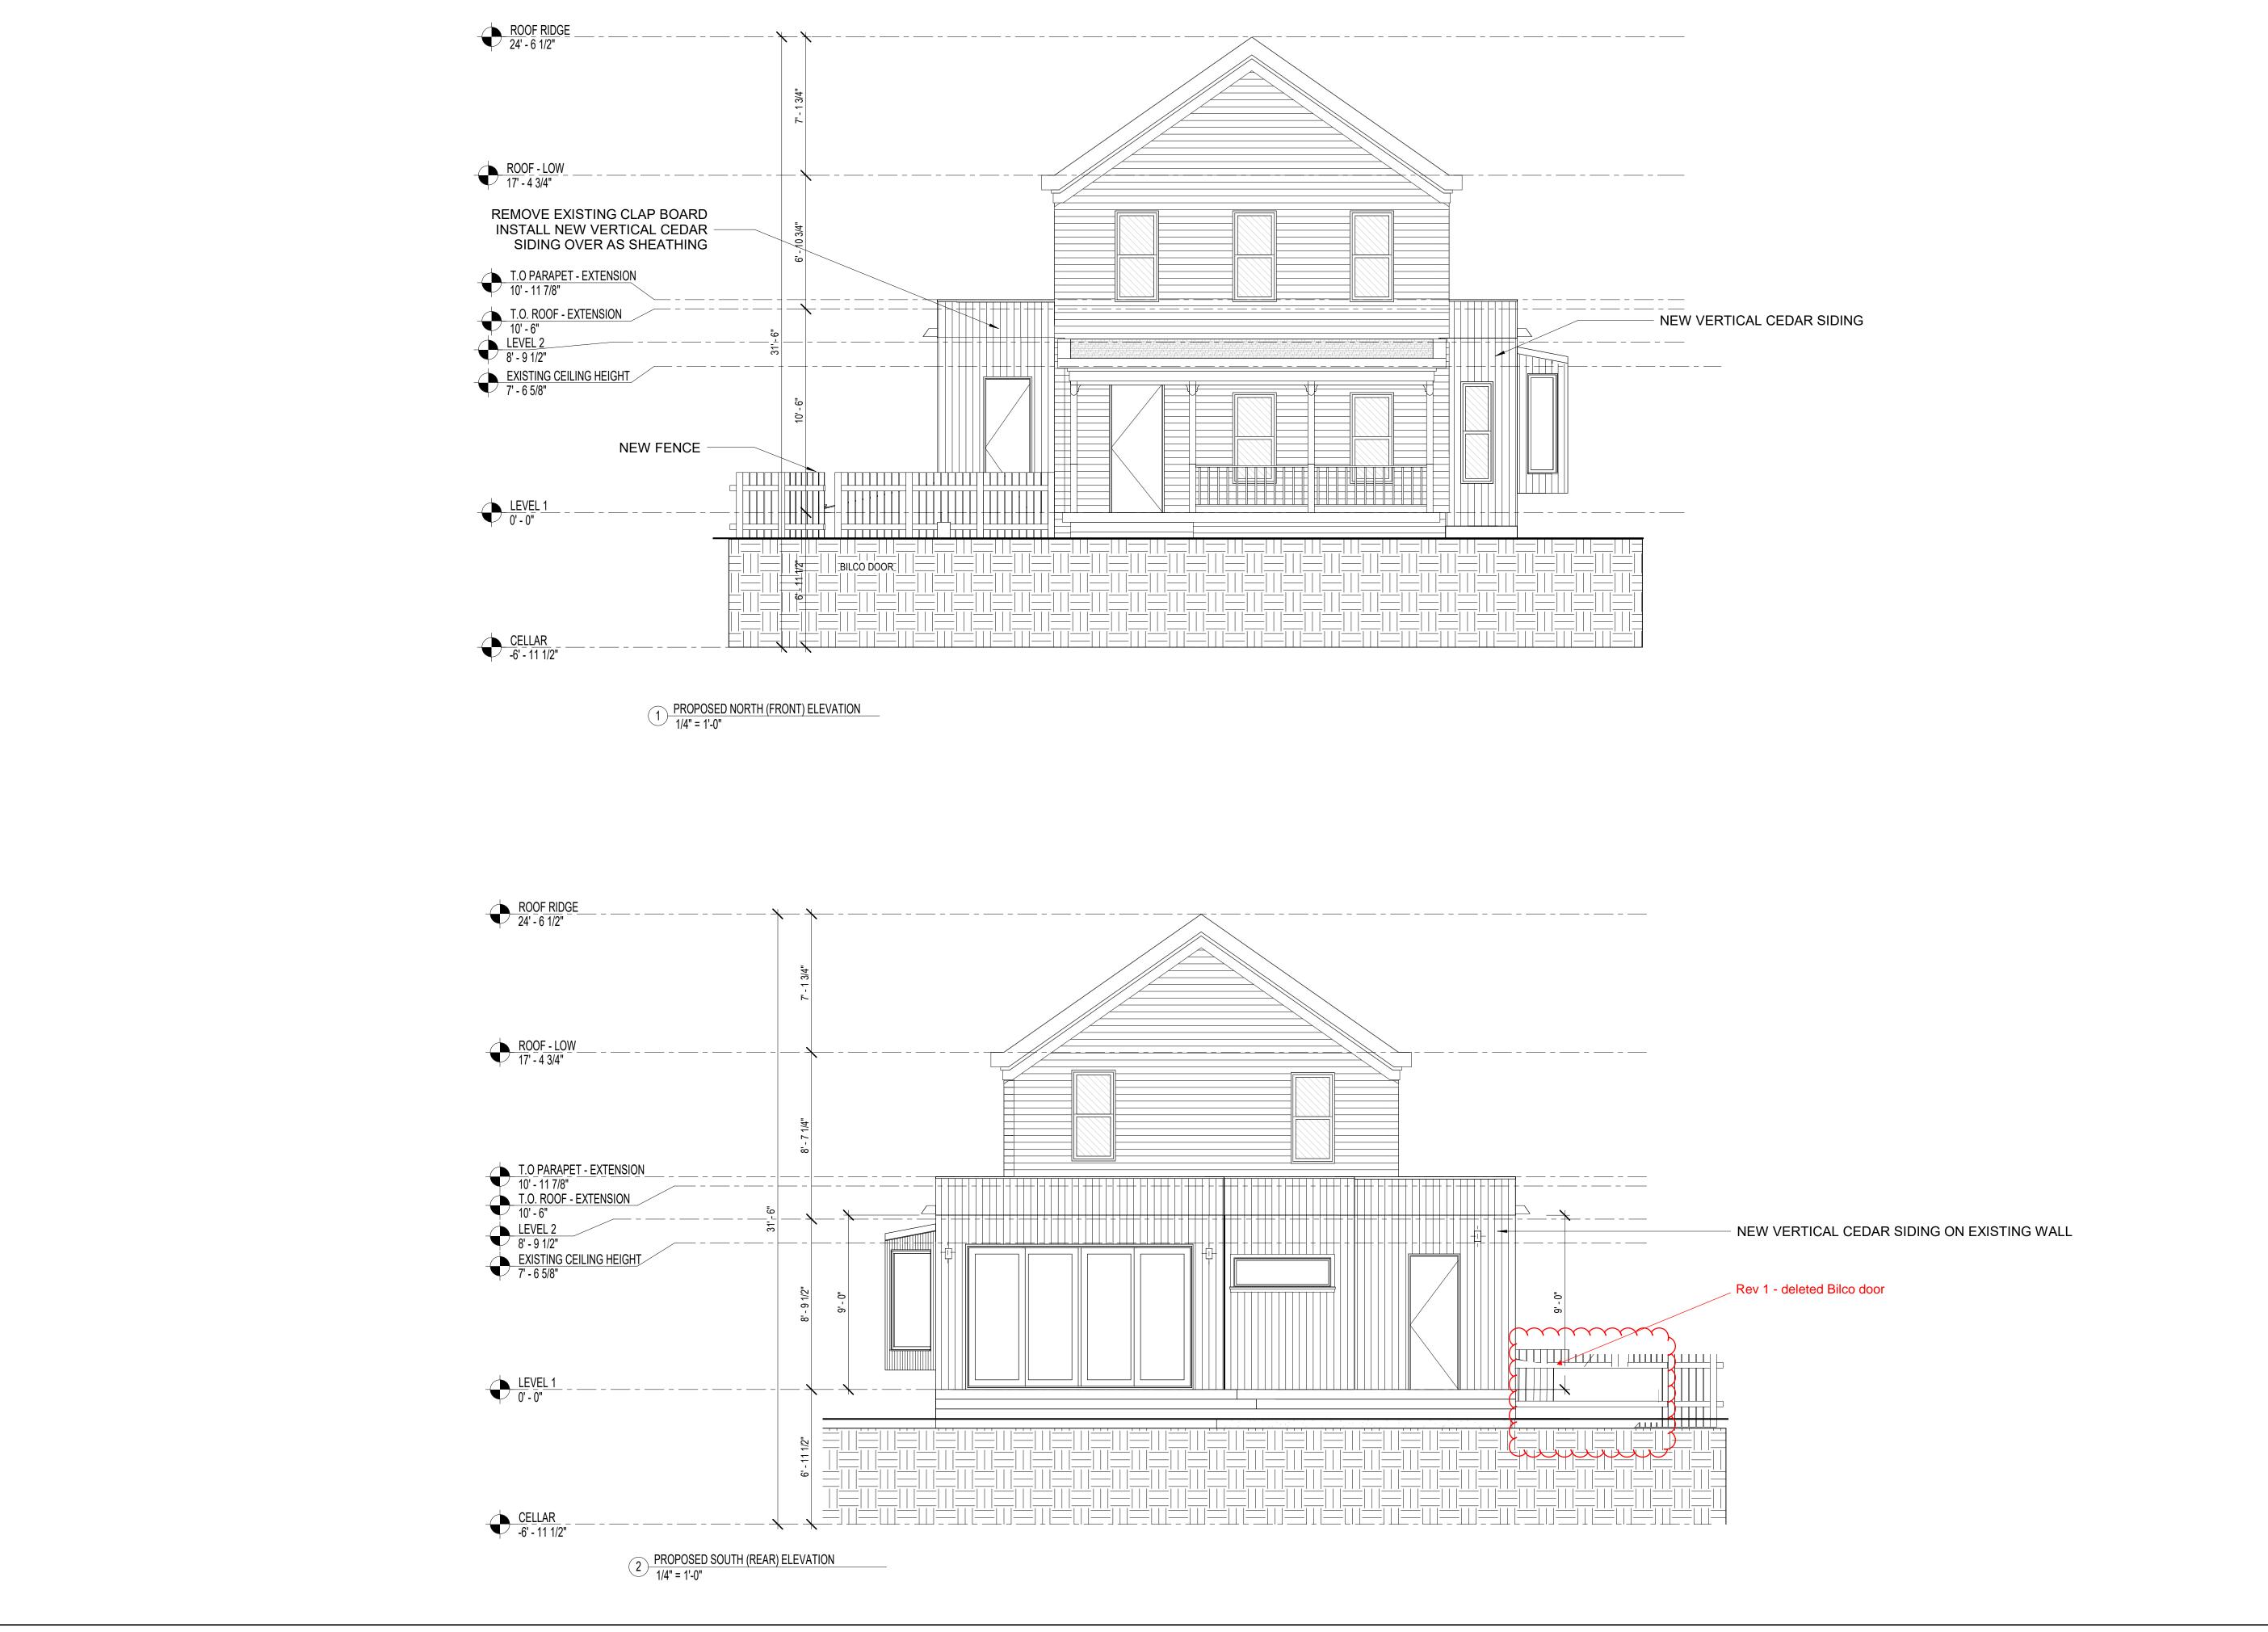

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ARCHITECT
THE TURETT COLLABORATIVE
277 BROADWAY, SUITE 1300
NEW YORK, NY, 10007

STRUCTURAL ENGINEER

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212.965.1244

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MECHANICAL ENGINEER

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A/V + IT CONSULTANT

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ACOUSTICAL CONSULTANT XXXX

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CONSULTANT 6 TYPE

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CONSULTANT 7 TYPE

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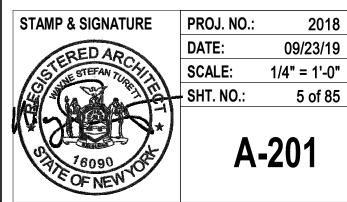
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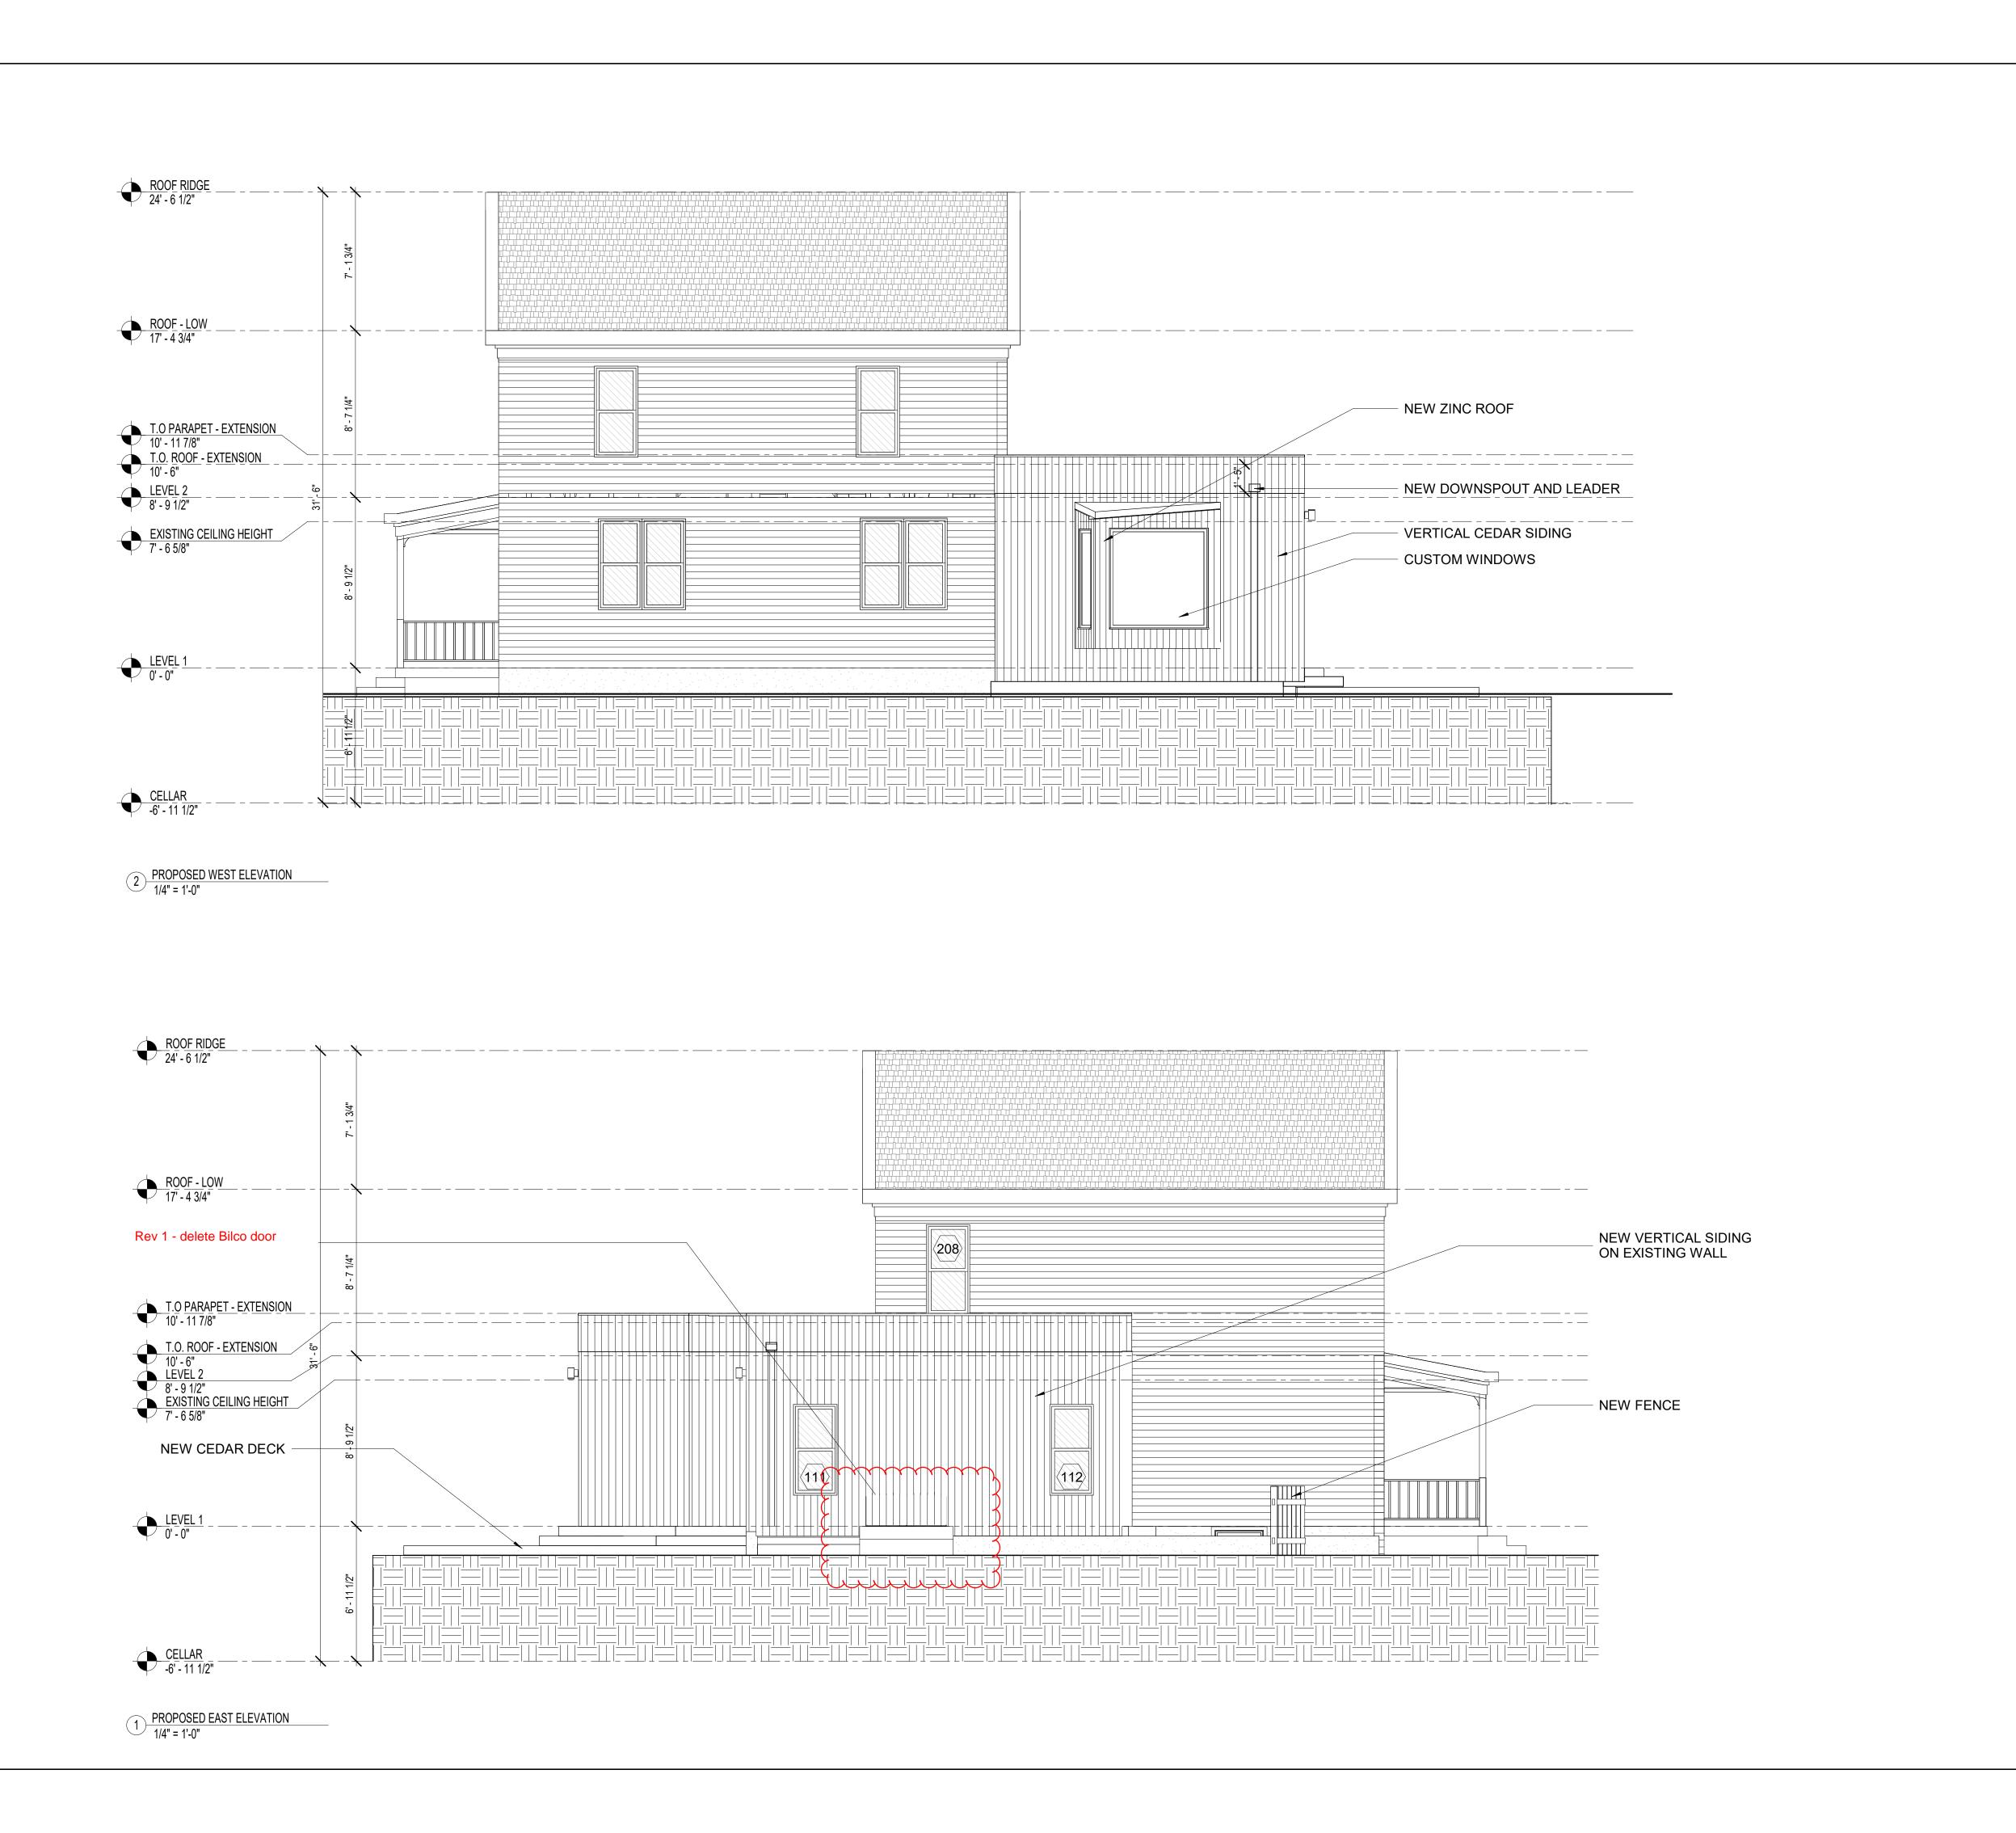
THE TURETT COLLABORATIVE:

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DRAWING TITLE

BUILDING ELEVATIONS - NORTH & SOUTH





ISSUE/REVISION

DA⁻

CONSULTANTS

ARCHITECT
THE TURETT COLLABORATIVE
277 BROADWAY, SUITE 1300
NEW YORK, NY, 10007
212.965.1244

STRUCTURAL ENGINEER

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MECHANICAL ENGINEER

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A/V + IT CONSULTANT

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ACOUSTICAL CONSULTANT

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CONSULTANT 6 TYPE

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CONSULTANT 7 TYPE

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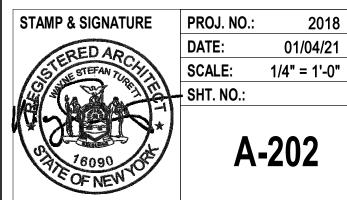
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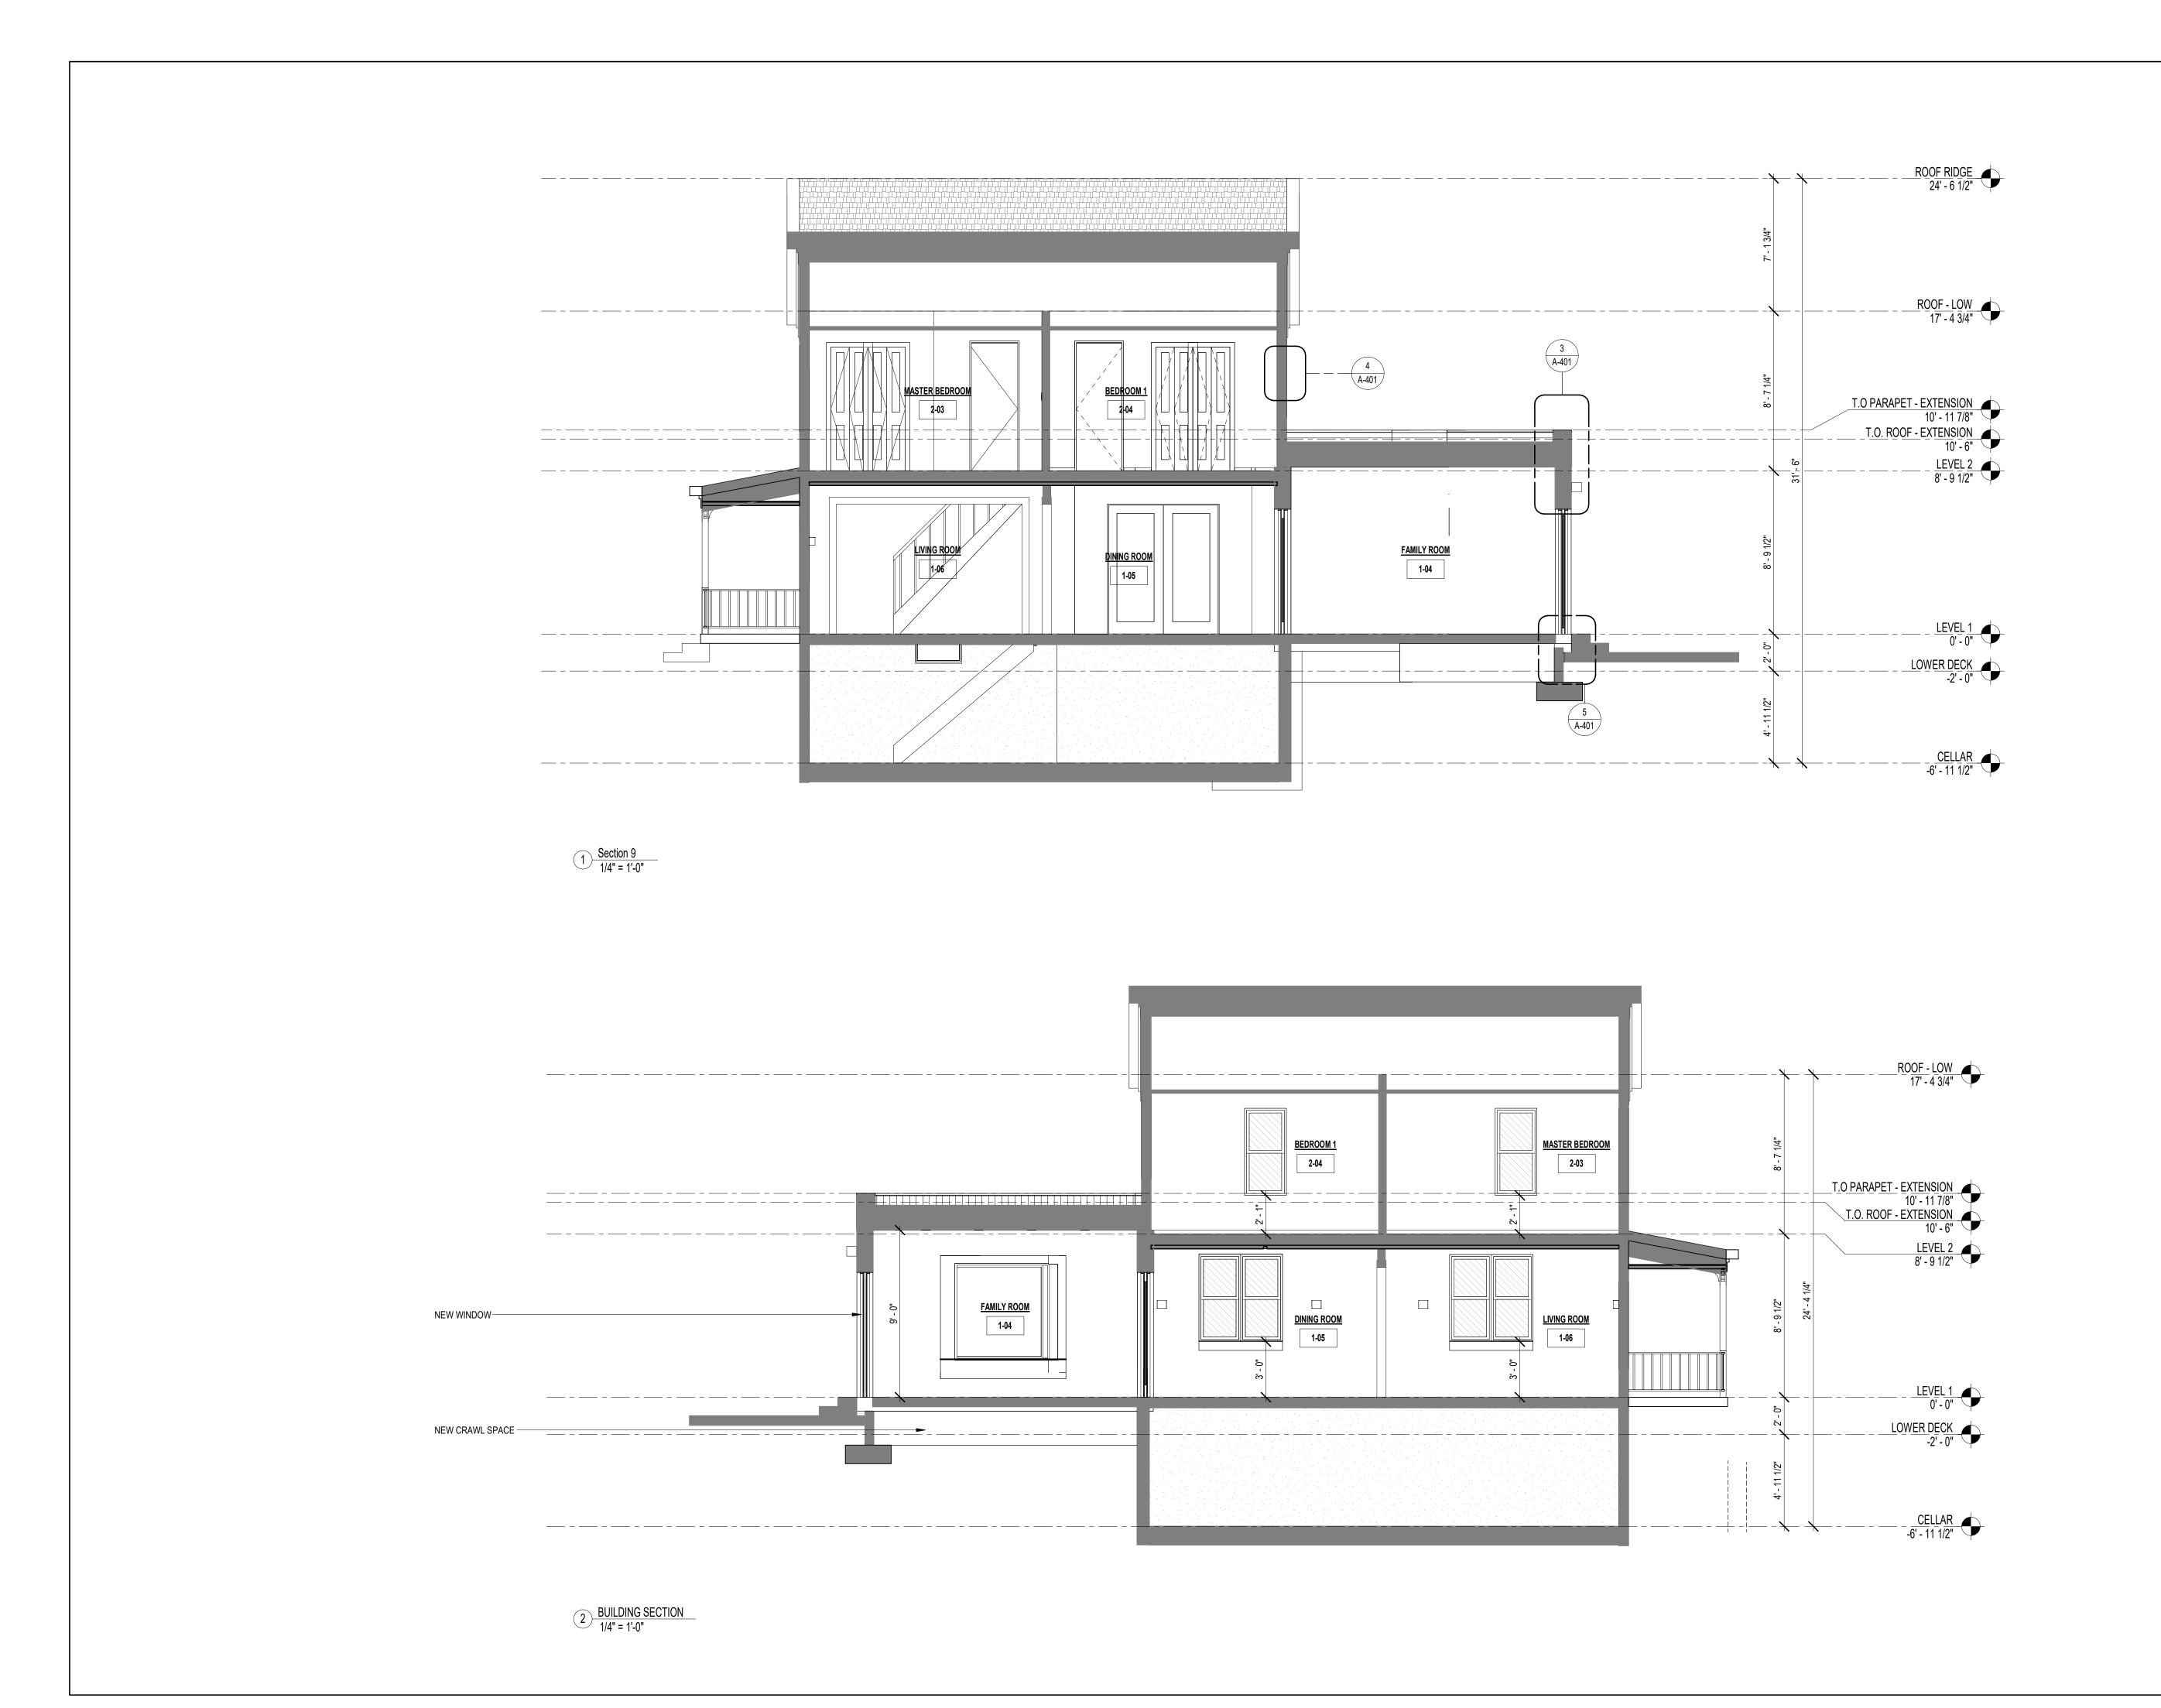
THE TURETT COLLABORATIVE:

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DRAWING TITLE

BUILDING ELEVATIONS -EAST & WEST





ISSUE/REVISION

DA

CONSULTANTS

ARCHITECT

THE TURETT COLLABORATIVE 277 BROADWAY, SUITE 1300 NEW YORK, NY, 10007 212.965.1244

STRUCTURAL ENGINEER

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MECHANICAL ENGINEER

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A/V + IT CONSULTANT

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ACOUSTICAL CONSULTANT

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CONSULTANT 6 TYPE

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CONSULTANT 7 TYPE

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THE TURETT COLLABORATIVE:

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T: 212.965 1244 | E: INFO@TURETTARCH.COM

DRAWING TITLE

BUILDING SECTION

STAMP & SIGNATURE


PROJ. NO.: 2018

DATE: 01/04/2

SCALE: 1/4" = 1'-0

SHT. NO.:

A-301

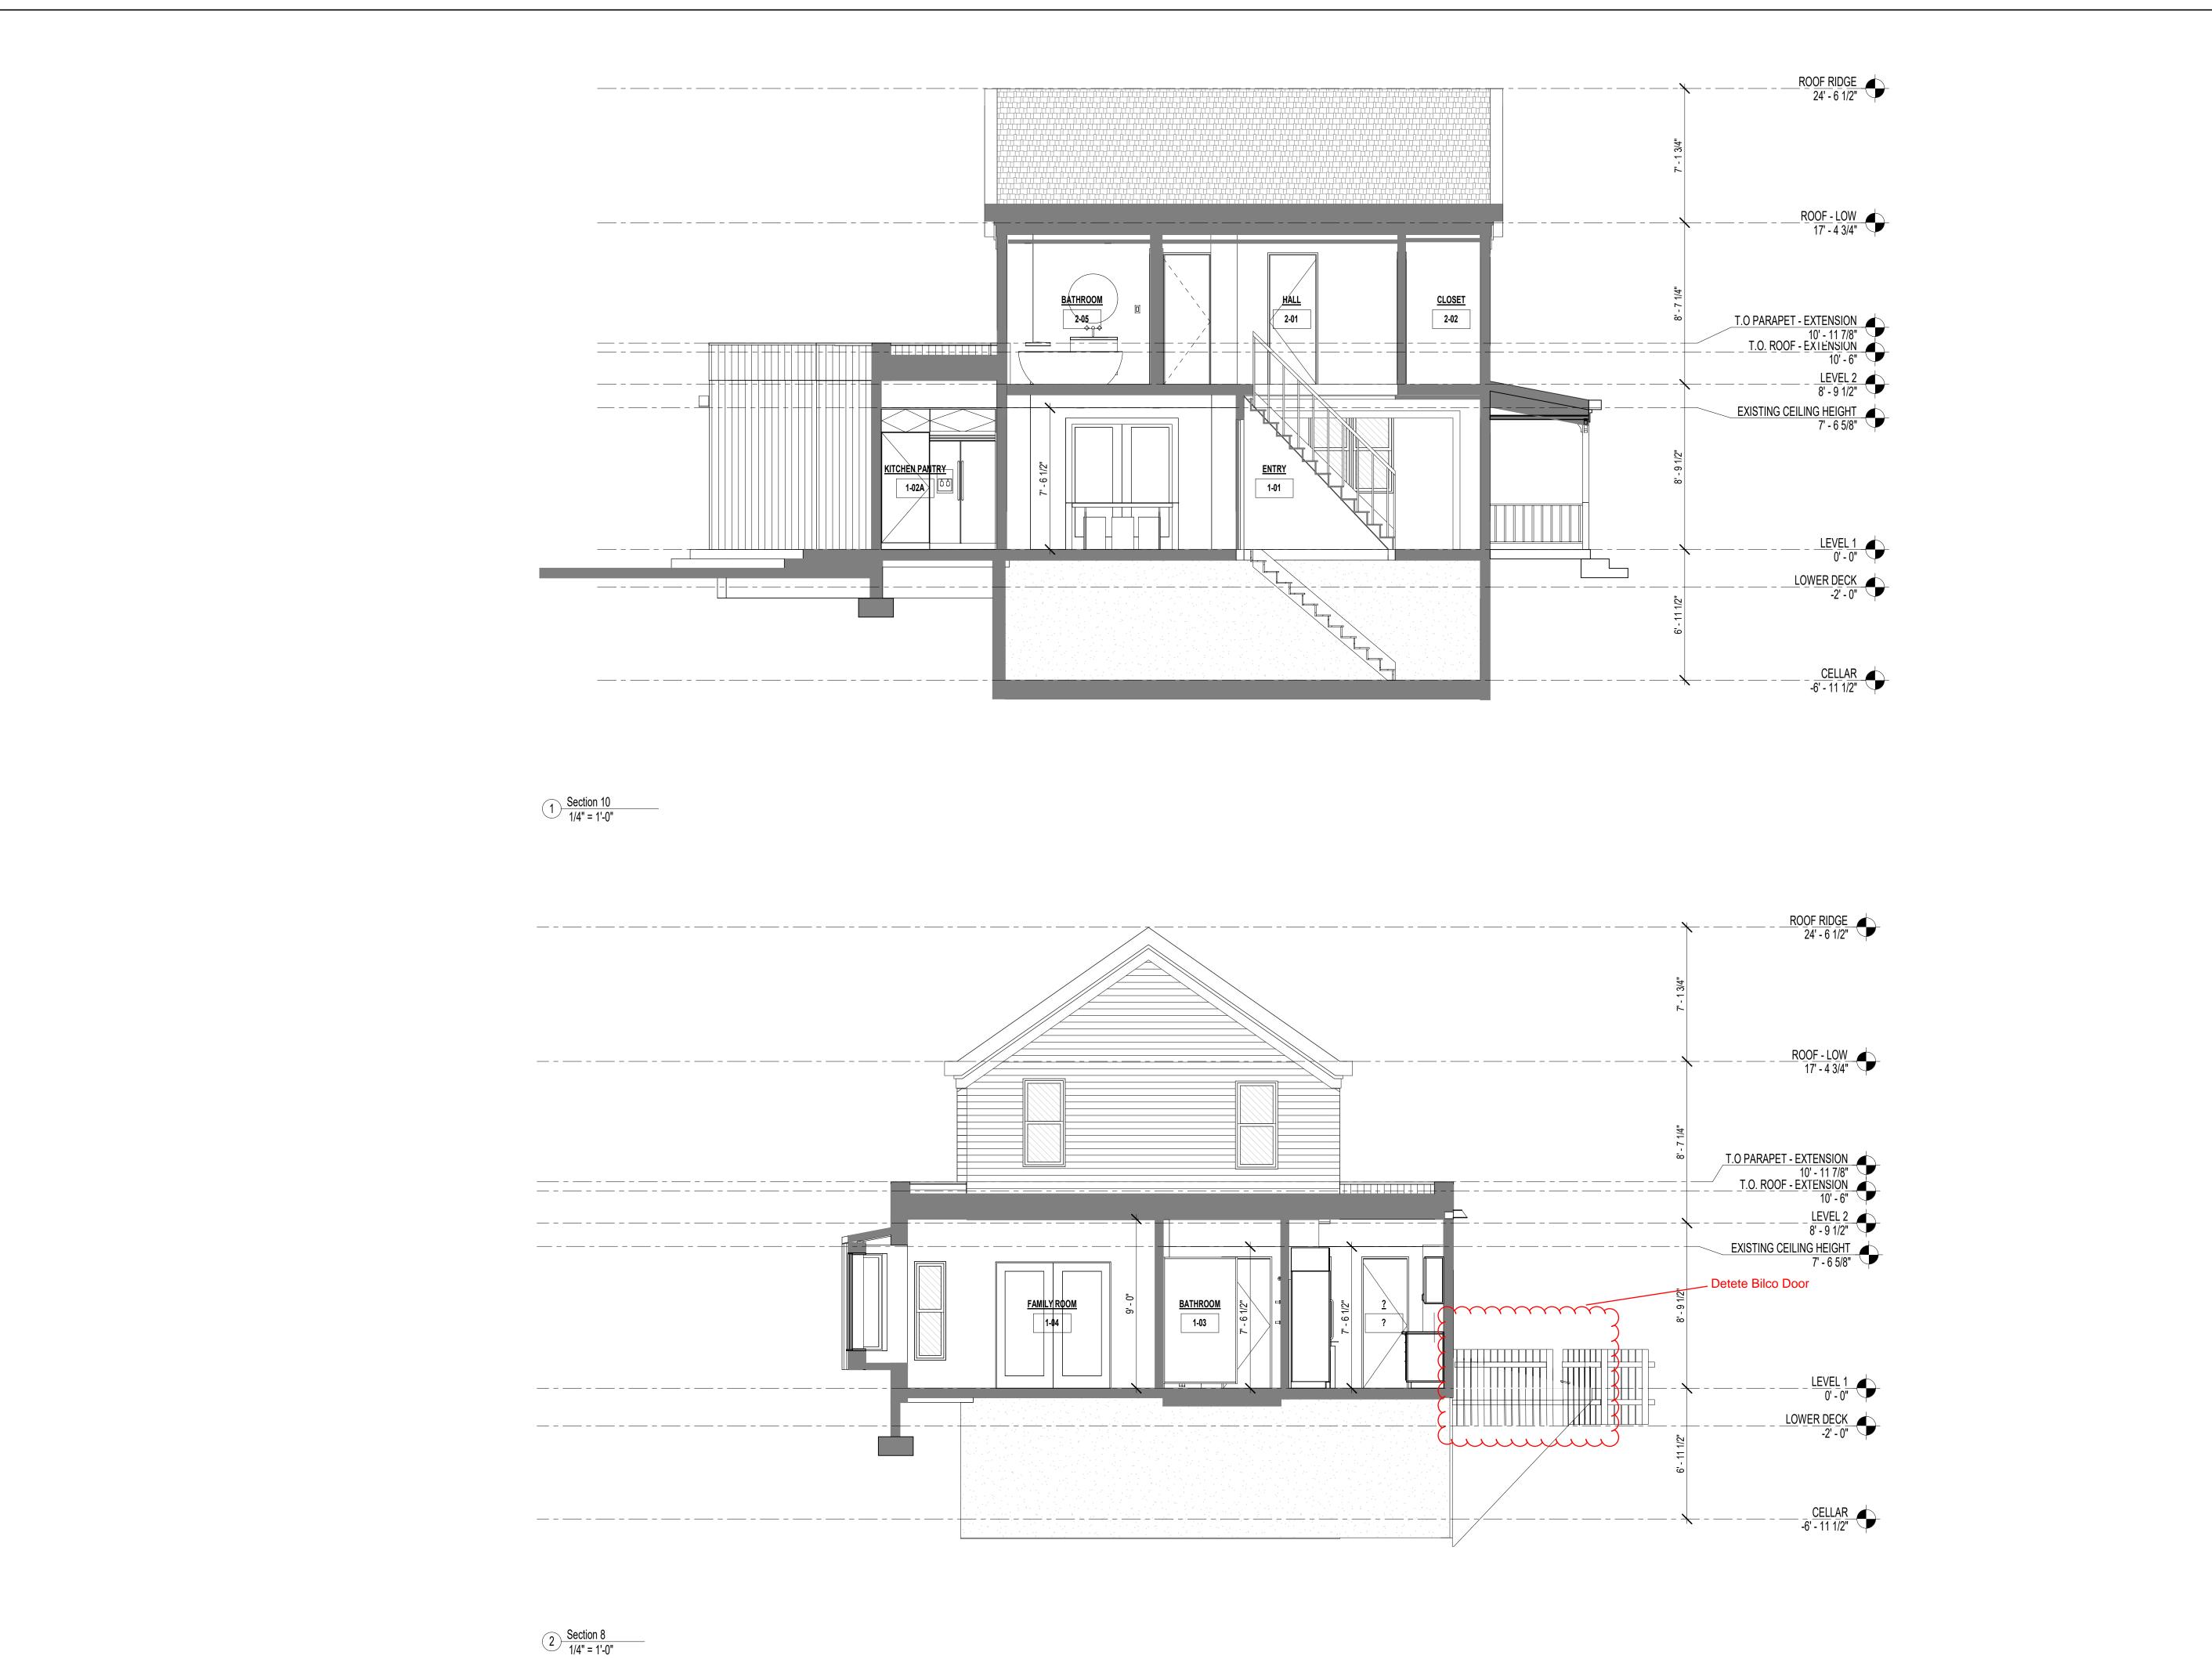

ISSUE/REVISION

Г

CONSULTANTS

ARCHITECT
THE TURETT COLLABORATIVE
277 BROADWAY, SUITE 1300
NEW YORK, NY, 10007

STRUCTURAL ENGINEER

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212.965.1244

MECHANICAL ENGINEER

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A/V + IT CONSULTANT

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ACOUSTICAL CONSULTANT

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CONSULTANT 6 TYPE
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CONSULTANT 7 TYPE

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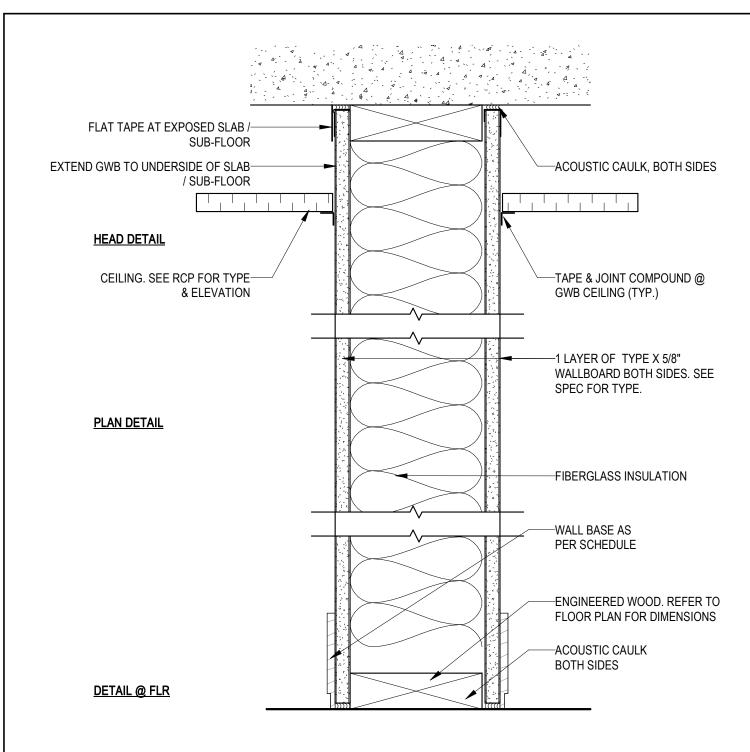
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DRAWING TITLE


BUILDING SECTION B


16090	Δ.	-302
A TOP	SHT. NO.:	
G THE STEFAN TURN THE	SCALE:	1/4" = 1'-0"
REDAR	DATE:	07/20/21
STAMP & SIGNATURE	PROJ. NO.:	2018



	PARTITION TYPE	STUD SIZE	OVERALL DIMENSION	STC RATING	UL DESIGN NO.
	A1	2 X 4	SEE PLANS		
	A2	2 X 6	SEE PLANS		
ſ					
Ī					

^{*} PROVIDE CEMENT BOARD AT WET AREA. TYP.

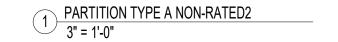

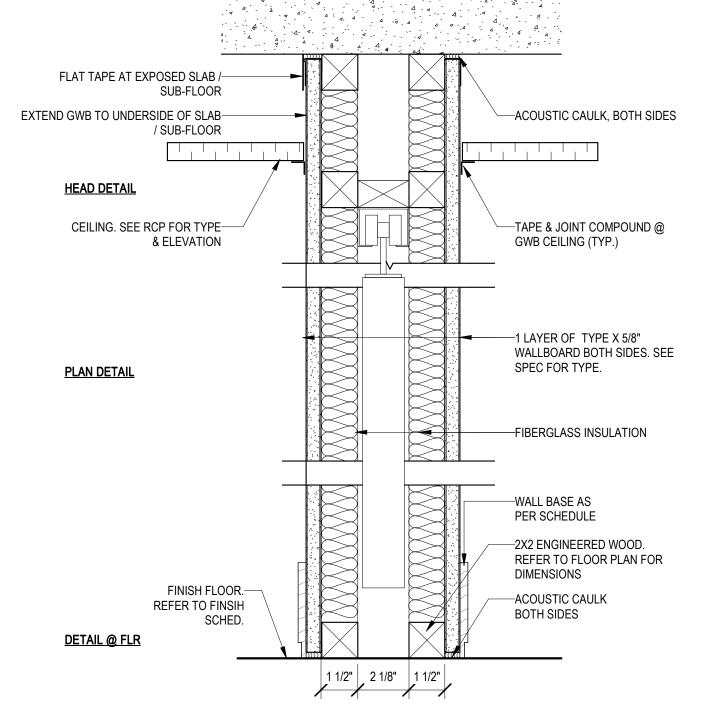

PARTITION TYPE	STUD SIZE	OVERALL DIMENSION	STC RATING	UL DESIGN NO.
C1	2x2	SEE PLANS		

PARTITION TYPE C - NON-RATED POCKET DOOR
3" = 1'-0"

225 MONSELL PLACE

ISSUE/REVISION DATE

1 Revision 1 08/04/2021

CONSULTANTS

ARCHITECT
THE TURETT COLLABORATIVE
277 BROADWAY, SUITE 1300
NEW YORK, NY, 10007
212.965.1244

THE TURETT COLLABORATIVE:

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DRAWING TITLE

PARTITION TYPES


STAMP & SIGNATURE PROJ. NO.: 2018

DATE: 04/15/2021

SCALE: 3" = 1'-0"

SHT. NO.:

A=601

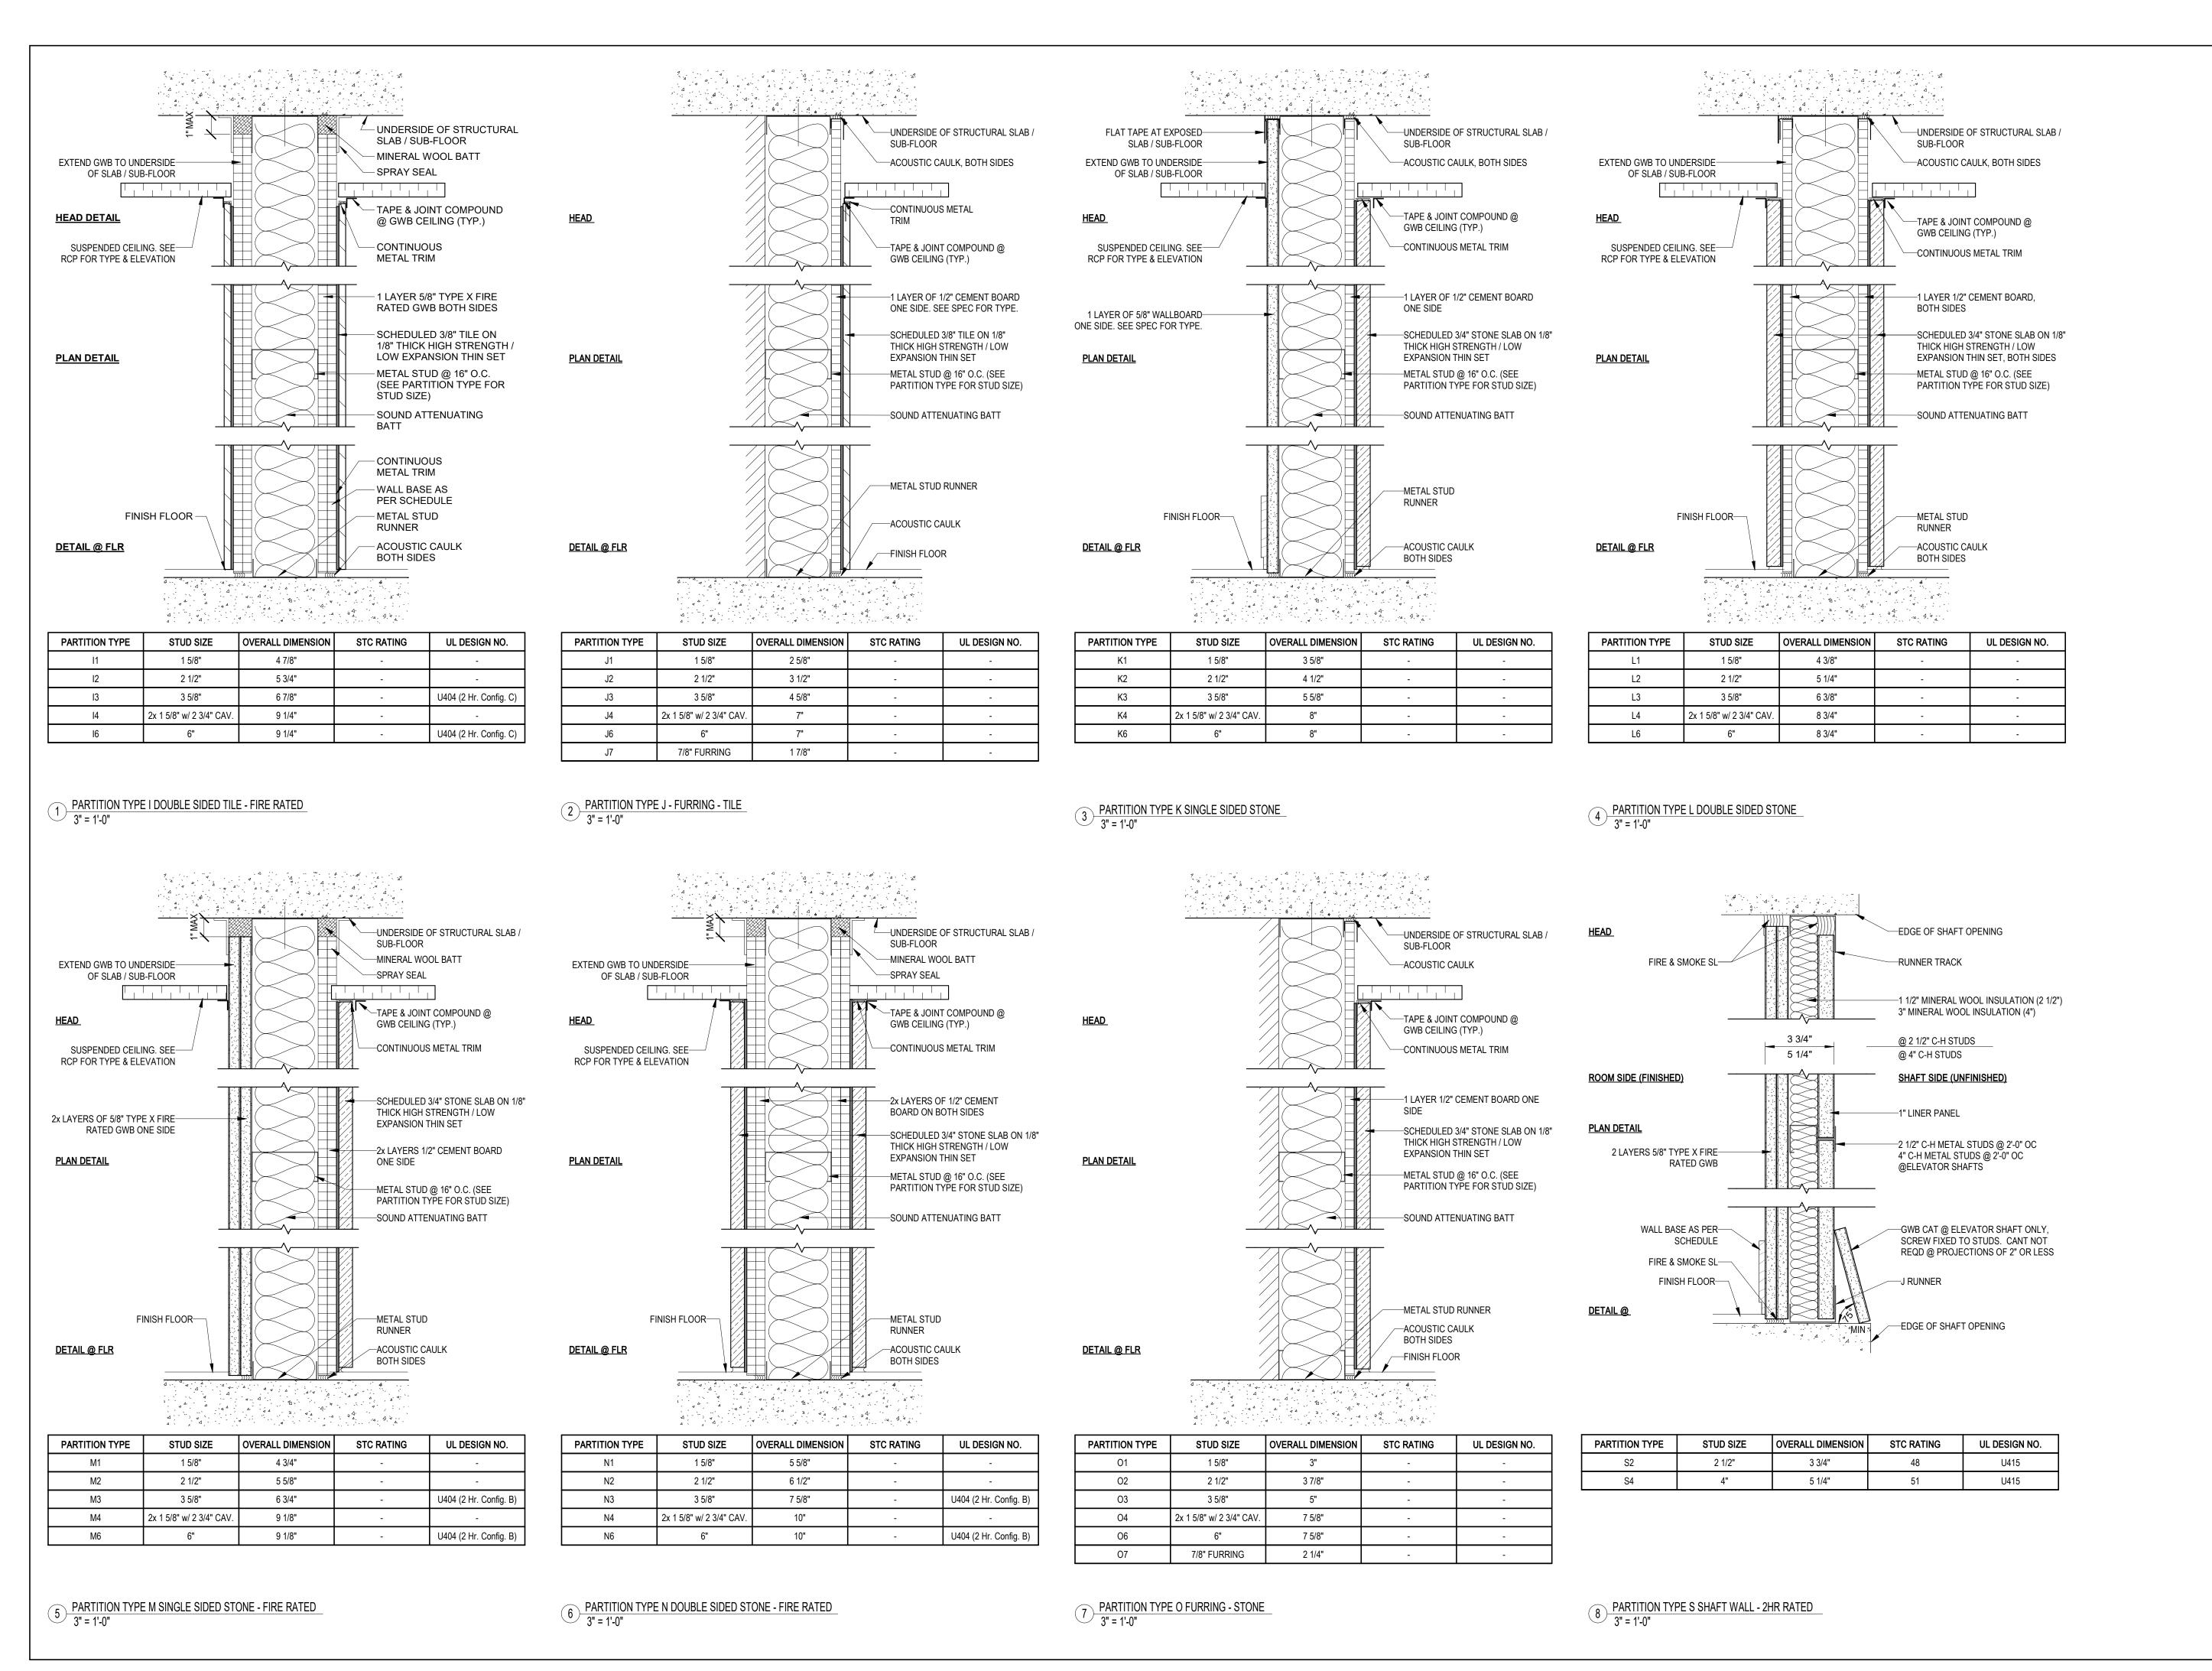

ISSUE/REVISION

CONSULTANTS

ARCHITECT THE TURETT COLLABORATIVE 277 BROADWAY, SUITE 1300 NEW YORK, NY, 10007 212.965.1244

STRUCTURAL ENGINEER

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MECHANICAL ENGINEER

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A/V + IT CONSULTANT

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ACOUSTICAL CONSULTANT

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CONSULTANT 6 TYPE

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XXXX **CONSULTANT 7 TYPE**

XXXX XXXX

XXXX XXXX

THE TURETT COLLABORATIVE:

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DRAWING TITLE

PARTITION TYPES CONT.

PROJ. NO.: STAMP & SIGNATURE 2018 02/28/20 SCALE: 3" = 1'-0" SHT. NO.:

			DOOR SCHEDL	II E	
			DOOK SOILDO		
101	2' - 8"	6' - 8"	0' - 1 3/8"	EXISTING TO REMAIN	
102	10' - 0"	7' - 0"	0' - 1 3/4"		
103	2' - 5 1/2"	6' - 8"	0' - 1 3/8"		
104	2' - 0"	6' - 8"	0' - 1 3/8"		
105	2' - 4"	6' - 8"	0' - 1 3/8"		
106	5' - 4"	6' - 8"	0' - 1 1/2"		
107	6' - 1"	7' - 0"	0' - 1 3/4"		
108	6' - 0"	6' - 8"	0' - 1 1/2"		
111	2' - 6"	7' - 0"	0' - 1 3/8"		
111	2' - 6"	7' - 0"	0' - 1 3/8"		
112	2' - 0"	6' - 8"	0' - 1 3/8"		
201	2' - 0"	6' - 8"	0' - 1 3/4"	EXISTING TO REMAIN	
202	2' - 0"	6' - 8"	0' - 1 1/2"	EXISTING TO REMAIN	
203	2' - 0"	6' - 8"	0' - 1 1/2"	EXISTING TO REMAIN	
204	2' - 6"	7' - 0"	0' - 1 3/8"	EXISTING TO REMAIN	
205	2' - 5 1/2"	6' - 8"	0' - 1 3/8"	EXISTING TO REMAIN	
205	2' - 5 1/2"	6' - 8"	0' - 1 3/8"	EXISTING TO REMAIN	
206	2' - 10"	7' - 0"	0' - 1 3/4"		
207	2' - 0"	6' - 8"	0' - 1 1/2"	EXISTING TO REMAIN	
208	2' - 0"	6' - 8"	0' - 1 1/2"	EXISTING TO REMAIN	
209	2' - 6"	7' - 0"	0' - 1 3/8"		
210	6' - 0"	6' - 8"	0' - 1 1/2"		

		WINDOW SCHE	EDULE
101	4' - 8 1/4"	2' - 3"	EXISTING TO REMAIN
102	4' - 8 1/4"	2' - 3"	EXISTING TO REMAIN
103	4' - 8 1/4"	2' - 3"	
103	4' - 8 1/4"	2' - 3"	
104	4' - 8 1/4"	2' - 3"	
104	4' - 8 1/4"	2' - 3"	
105	4' - 8 1/4"	2' - 3"	
105	4' - 8 1/4"	2' - 3"	
106	4' - 8 1/4"	2' - 3"	
106	4' - 8 1/4"	2' - 3"	
107	5' - 3"	1' - 8"	
108	5' - 2"	1' - 8"	
109	4' - 9 1/2"	2' - 0"	
110	1' - 6"	5' - 0"	
111	4' - 8 1/4"	2' - 3"	
112	4' - 8 1/4"	2' - 3"	
114	1' - 4"	2' - 6"	
115	4' - 8 1/4"	2' - 3"	
201	4' - 8 1/4"	2' - 3"	EXISTING TO REMAIN
202	4' - 8 1/4"	2' - 3"	EXISTING TO REMAIN
203	4' - 8 1/4"	2' - 3"	EXISTING TO REMAIN
204	4' - 8 1/4"	2' - 3"	EXISTING TO REMAIN
205	4' - 8 1/4"	2' - 3"	EXISTING TO REMAIN
206	4' - 8 1/4"	2' - 3"	EXISTING TO REMAIN
207	4' - 8 1/4"	2' - 3"	EXISTING TO REMAIN
208	4' - 8 1/4"	2' - 3"	
209	4' - 8 1/4"	2' - 3"	

	Finish Schedule					
Number	Name	Level	Base Finish	Wall Finish	Trim	Ceiling Finish
1-01	ENTRY	LEVEL 1				
1-02	KITCHEN	LEVEL 1				
1-02	KITCHEN	LEVEL 1				
1-02A	KITCHEN PANTRY	LEVEL 1				
1-03	BATHROOM	LEVEL 1	WOOD PTD TO MATCH	SAME AS EX'G PTD	PTD SAME AS EX'G	PTD
1-04	FAMILY ROOM	LEVEL 1	WOOD PTD TO MATCH EX'G	SHOWER TILE T-1 DRY WALL PTD	PTD SAME AS EX'G	PTD
1-05	DINING ROOM	LEVEL 1				
1-06	LIVING ROOM	LEVEL 1				
2-01	HALL	LEVEL 2				
2-02	CLOSET	LEVEL 2				
2-03	MASTER BEDROOM	LEVEL 2				
2-03A	CLOSET	LEVEL 2				
2-04	BEDROOM 1	LEVEL 2				
2-04A	CLOSET	LEVEL 2				
2-05	BATHROOM	LEVEL 2	WOOD PTD TO MATCH EX'G	WOOD WAINSCOT PTD		PTD

ISSUE/REVISION DATE

CONSULTANTS

ARCHITECT

THE TURETT COLLABORATIVE 277 BROADWAY, SUITE 1300 NEW YORK, NY, 10007 212.965.1244

STRUCTURAL ENGINEER

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MECHANICAL ENGINEER

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XXXX A/V + IT CONSULTANT

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ACOUSTICAL CONSULTANT

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CONSULTANT 6 TYPE

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CONSULTANT 7 TYPE

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THE TURETT COLLABORATIVE:

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DRAWING TITLE

DOOR AND WINDOW SCHEDULE

16090	A
	SHT. NO.:
G TEFAN TUR	SCALE:
REDAD	DATE:
STAMP & SIGNATURE	PROJ. NO.:

A-701